

Landscape Design

Creating outdoor spaces to be enjoyed by people and wildlife
across time that are functional, environmentally responsive
and beautiful

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Creating outdoor spaces to be enjoyed by people and wildlife
across time that are functional, environmentally responsive
and beautiful

Minimize cost

Minimize negative environment impact

Design Process

Program Requirements
(What the client wants)


Document Existing Conditions
(What exists now)


Explore what's possible with the site
(Bubble Diagrams)

Decide on the design that fulfills the requirements best

Convert the bubbles into actual plants

How to read a Site Plan

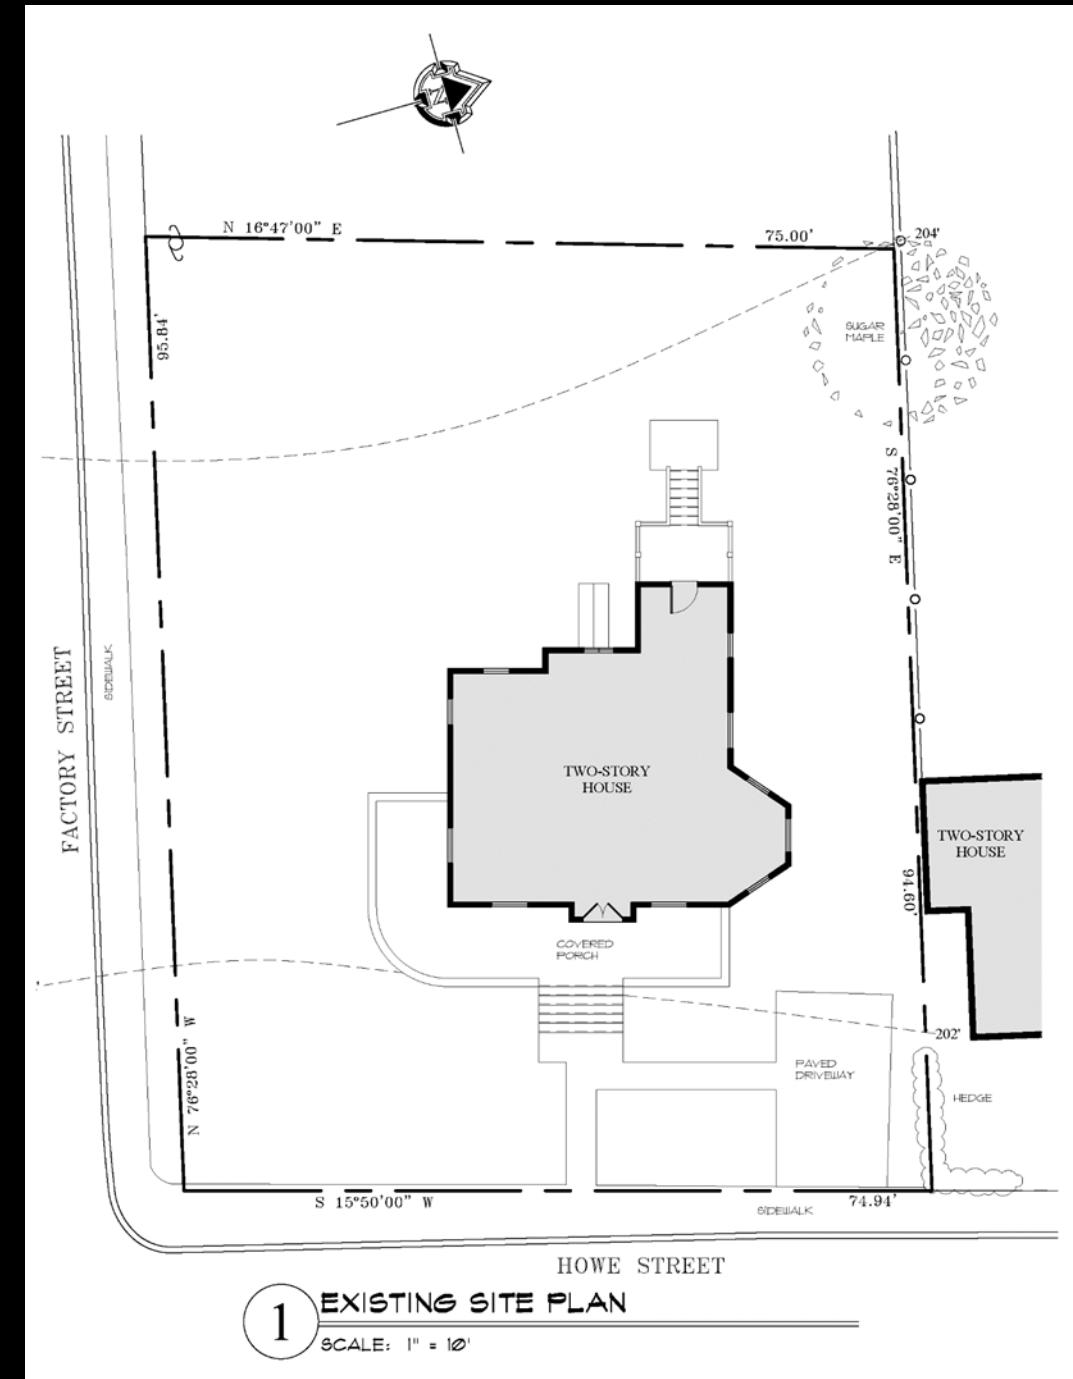

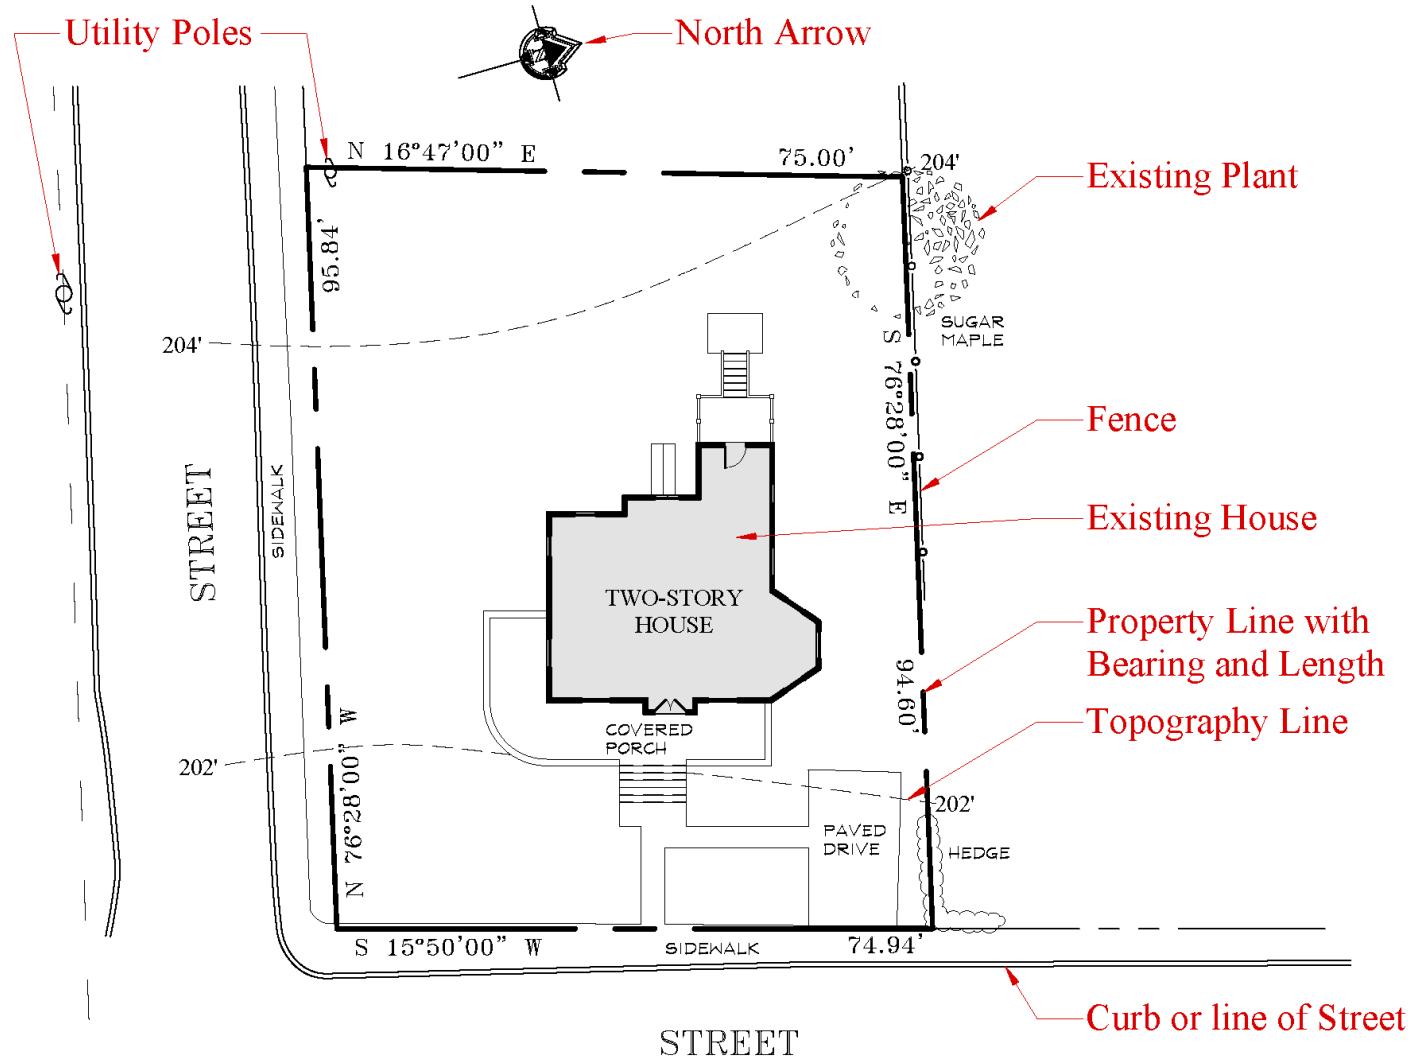

Drawing Number -

1

SITE PLAN


—Drawing Name

SCALE: 1" = 20' ← Scale


Base Plan / Basic Survey



Base Plan with Topography

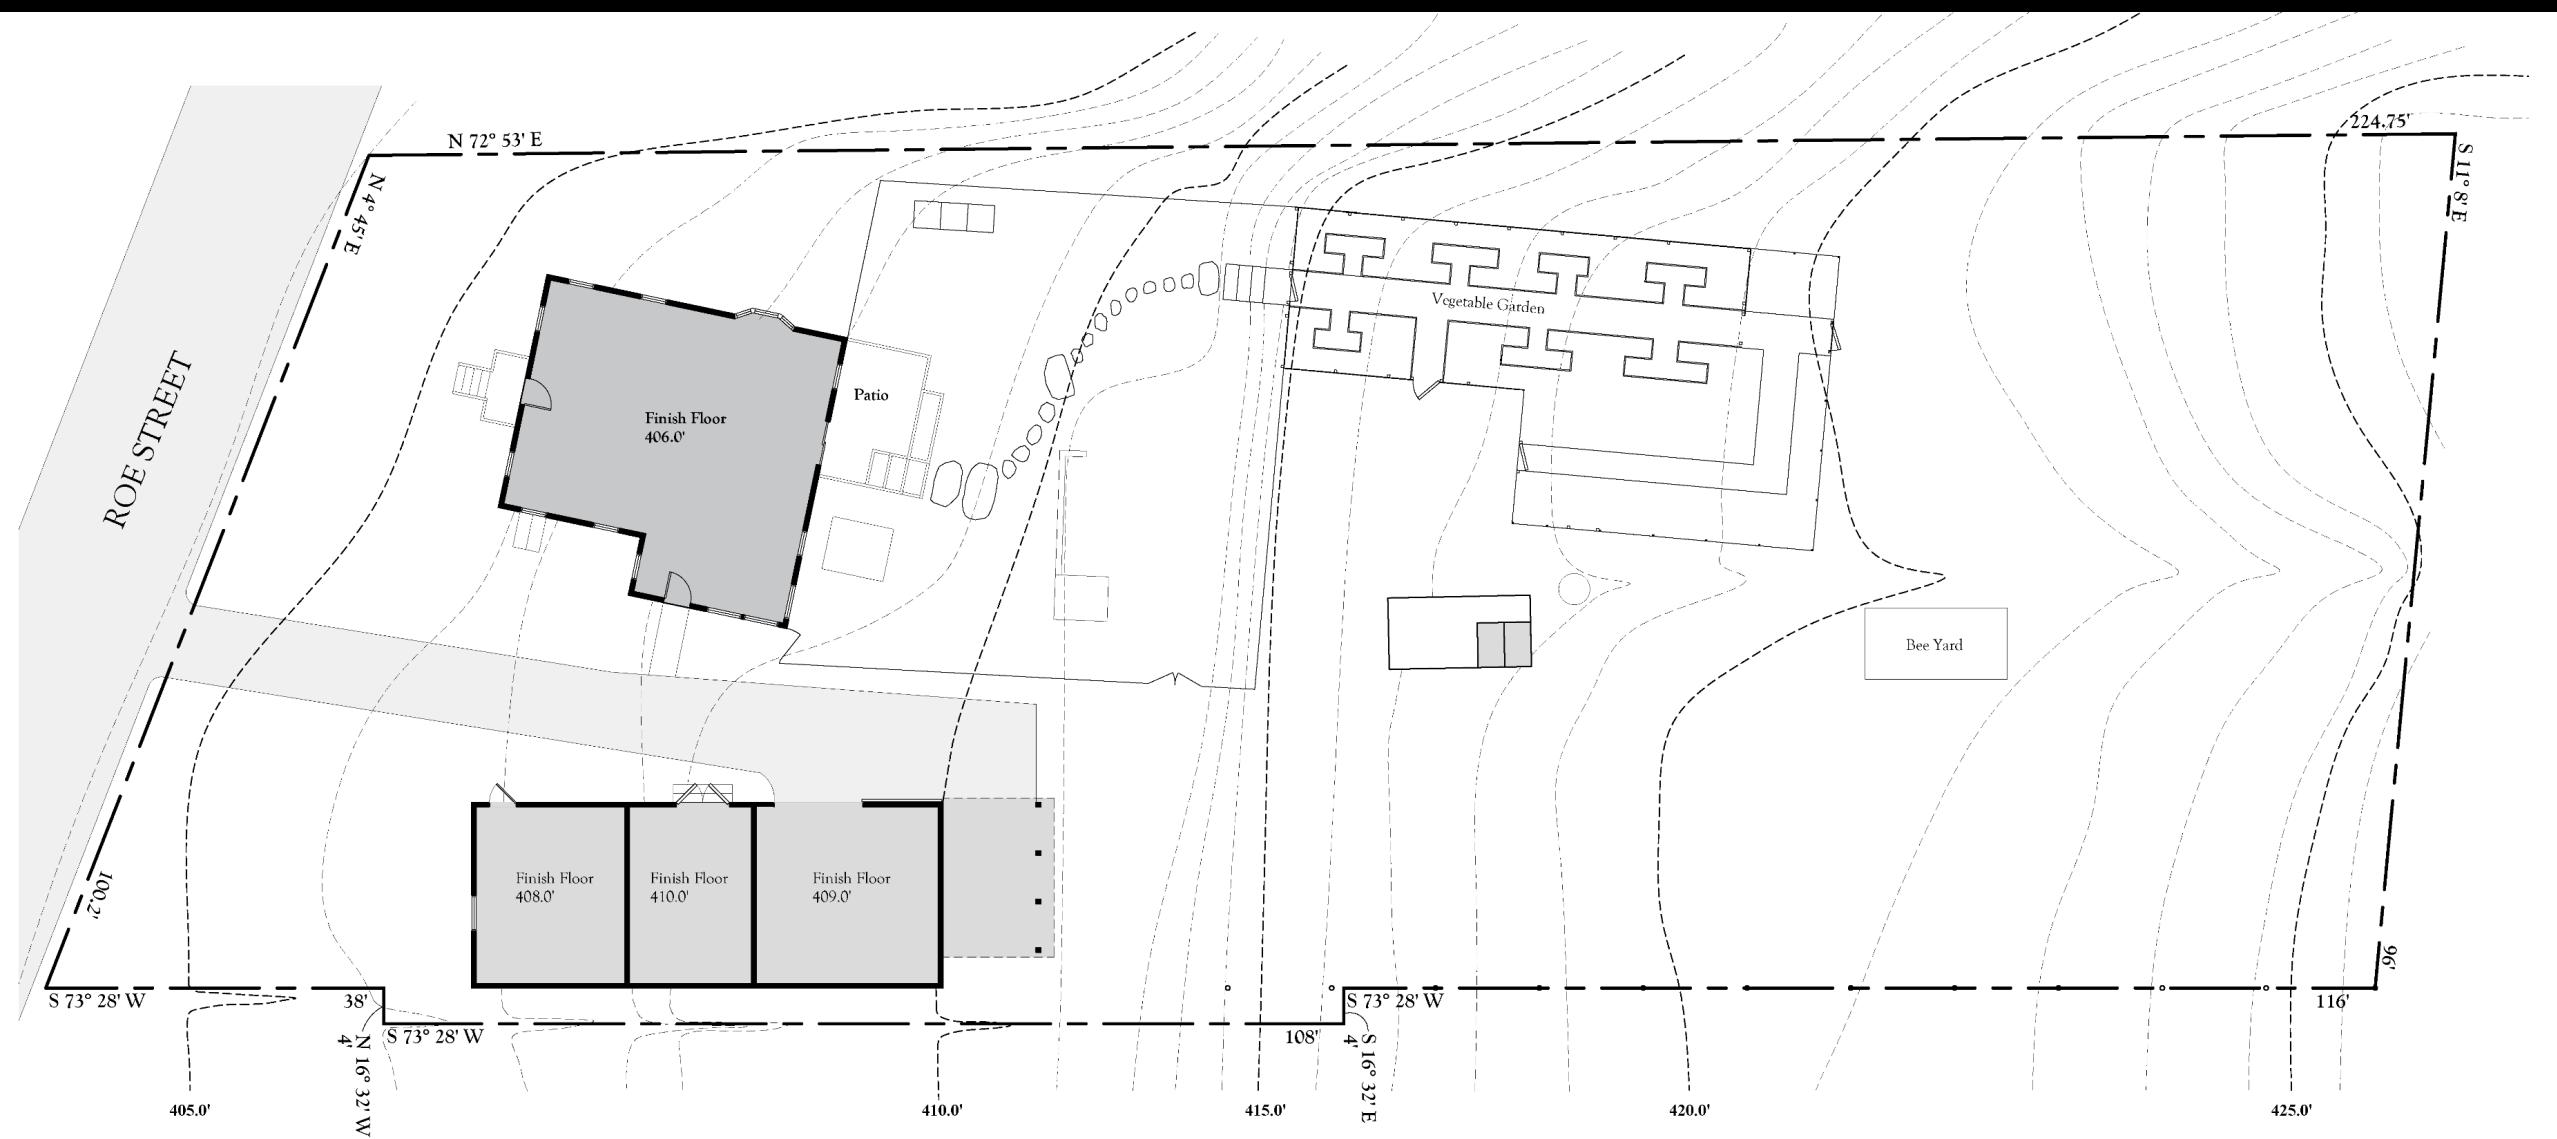

Existing Conditions Plan

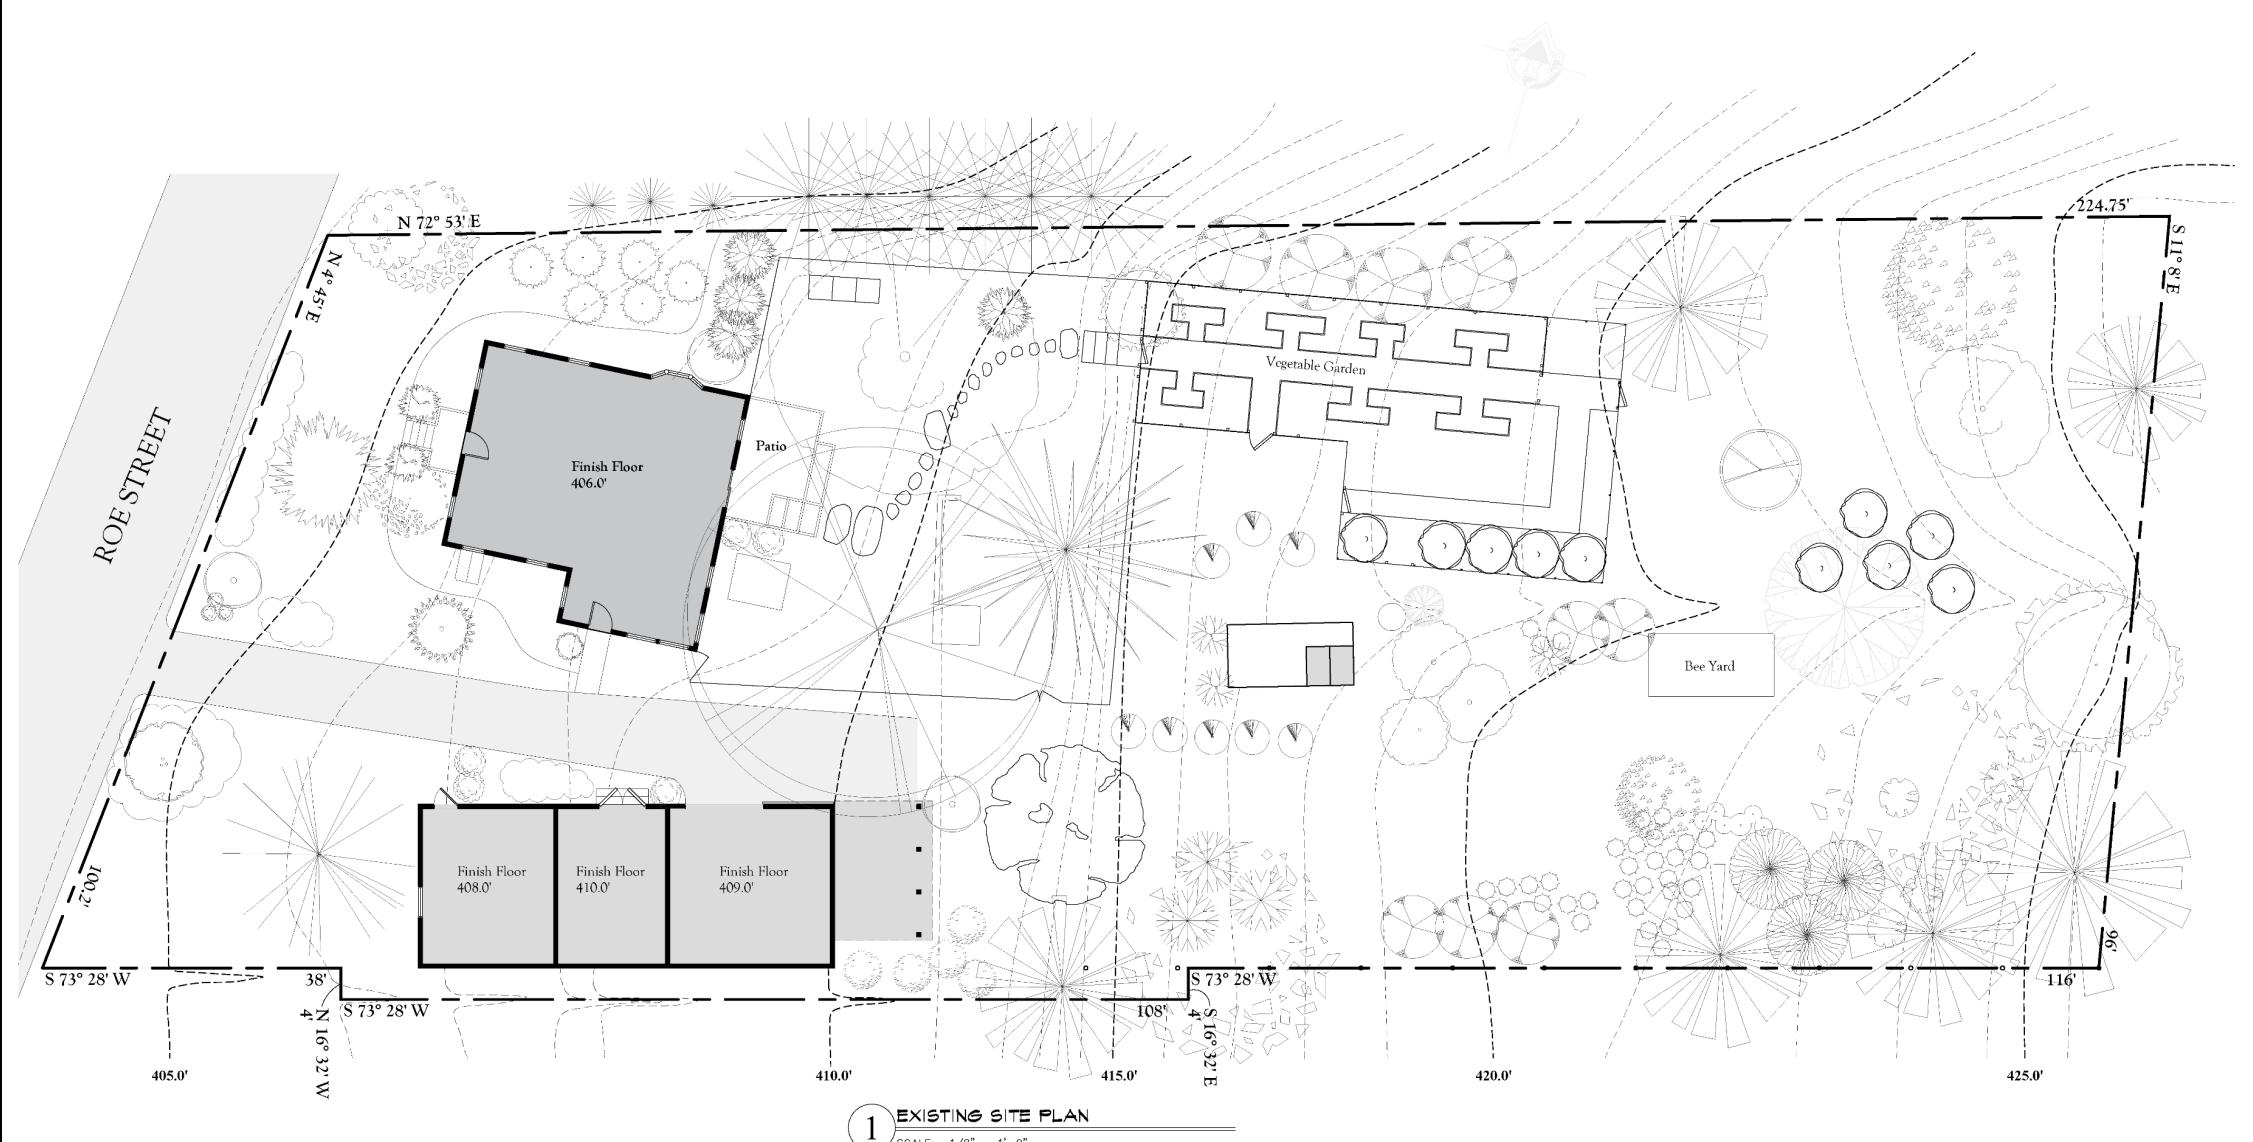

WOODY PLANT KEY

<i>Juglans nigra</i> , Black Walnut	<i>Betula papyrifera</i> , Paper Birch	<i>Juniperus virginiana</i> , Eastern Redcedar	<i>Cornus florida</i> , White Dogwood	<i>Cotoneaster spp.</i> , Cotoneaster	<i>Spirea prunifolia</i> , Bridal Wreath Spirea	<i>Buxus spp.</i> , Boxwood	<i>Cercis canadensis</i> , Redbud
<i>Quercus coccinea</i> , Scarlet Oak	<i>Acer Saccharinum</i> , Silver Maple	<i>Pinus strobus</i> , White Pine	<i>Prunus serrulata</i> 'Kanzan', Kanzan Cherry	<i>Aronia melanocarpa</i> , Chokeberry	<i>Ilex x meserveae</i> 'Mesog', China Girl Holly	<i>Juniperus horizontalis</i> , Blue Rug Juniper	<i>Prunus virginiana</i> , Chokecherry
<i>Quercus alba</i> , White Oak	<i>Picea abies</i> , Norway Spruce	<i>Picea pungens</i> , Colorado Blue Spruce	<i>Forsythia spp.</i> , Forsythia	<i>Panicum virgatum</i> , Switchgrass	<i>Viburnum spp.</i> , Viburnum	<i>Ulmus americana</i> , American Elm	<i>Myrica pensylvanica</i> , Bayberry
<i>Rhus typhina</i> , Staghorn Sumac	<i>Morus rubra</i> , Mulberry	<i>Syringa vulgaris</i> , Lilac	<i>Philadelphus spp.</i> , Mock-orange	<i>Betula populifolia</i> , Gray Birch	<i>Viburnum trilobum</i> , Highbush Cranberry	<i>Amelanchier arborea</i> , Downy Serviceberry	<i>Malus spp.</i> , Crabapple
<i>Hibiscus syriacus</i> , Rose of Sharon				<i>Cornus racemosa</i> , Gray Dogwood			

Field Measuring


Tools:

Tape Measure
String
Laser
Transit


Methods:

Triangulation
Alignment
String
Vertical Measurements


Triangulation

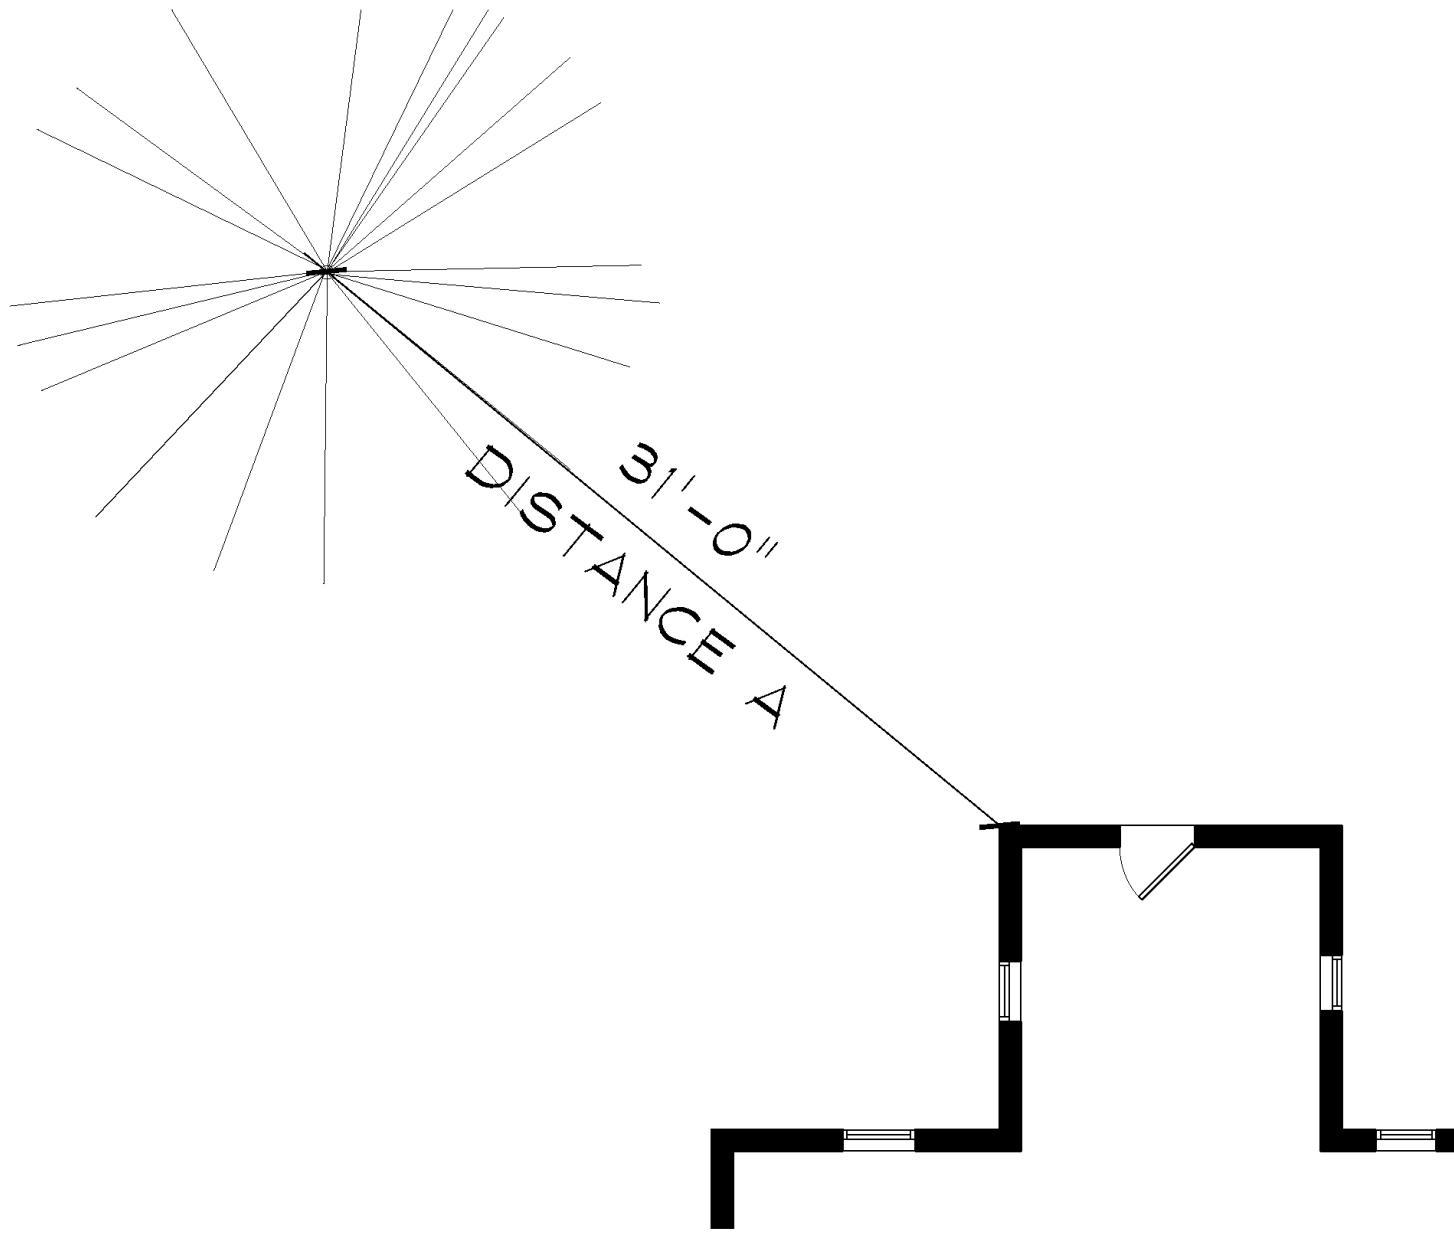

Triangulation

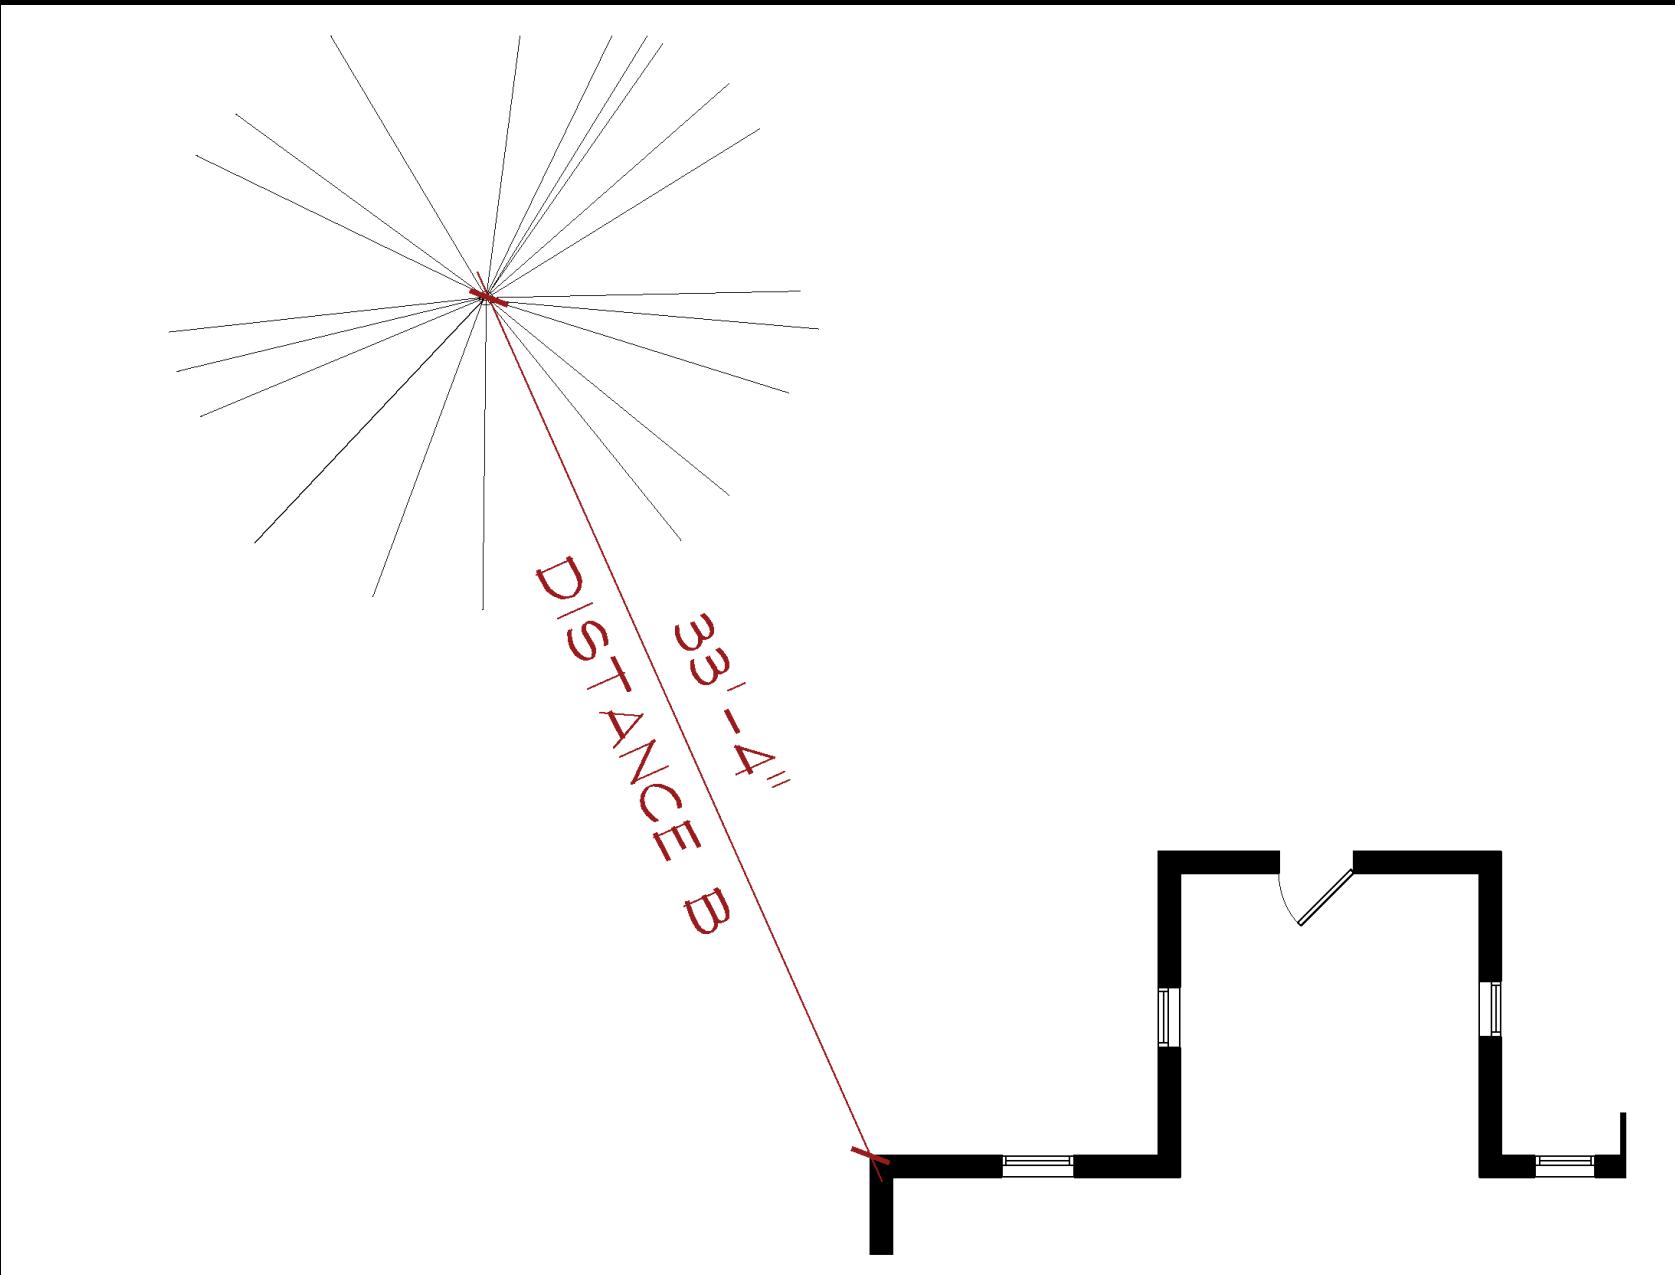

Triangulation

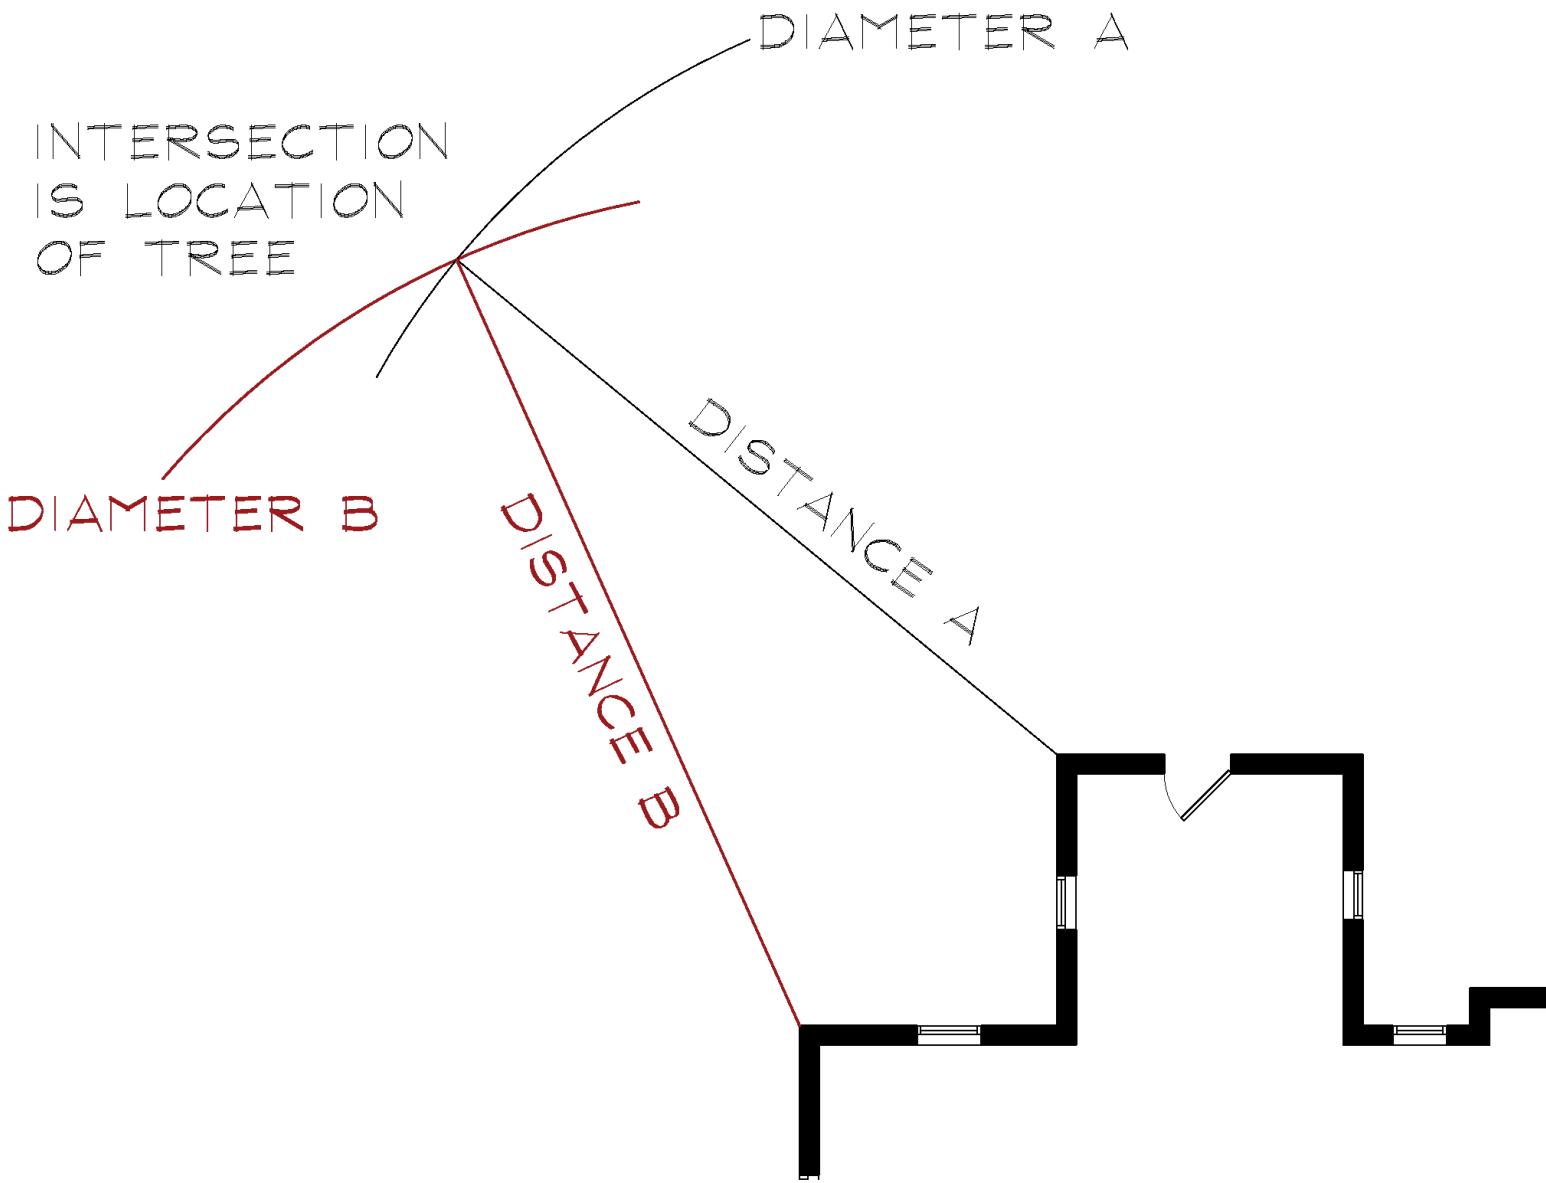

Site Analysis

Site Analysis

Shade

Sun

Water/Wet spots

Soil


Undesirable Views

Wind

Noises


Site Analysis

Shade

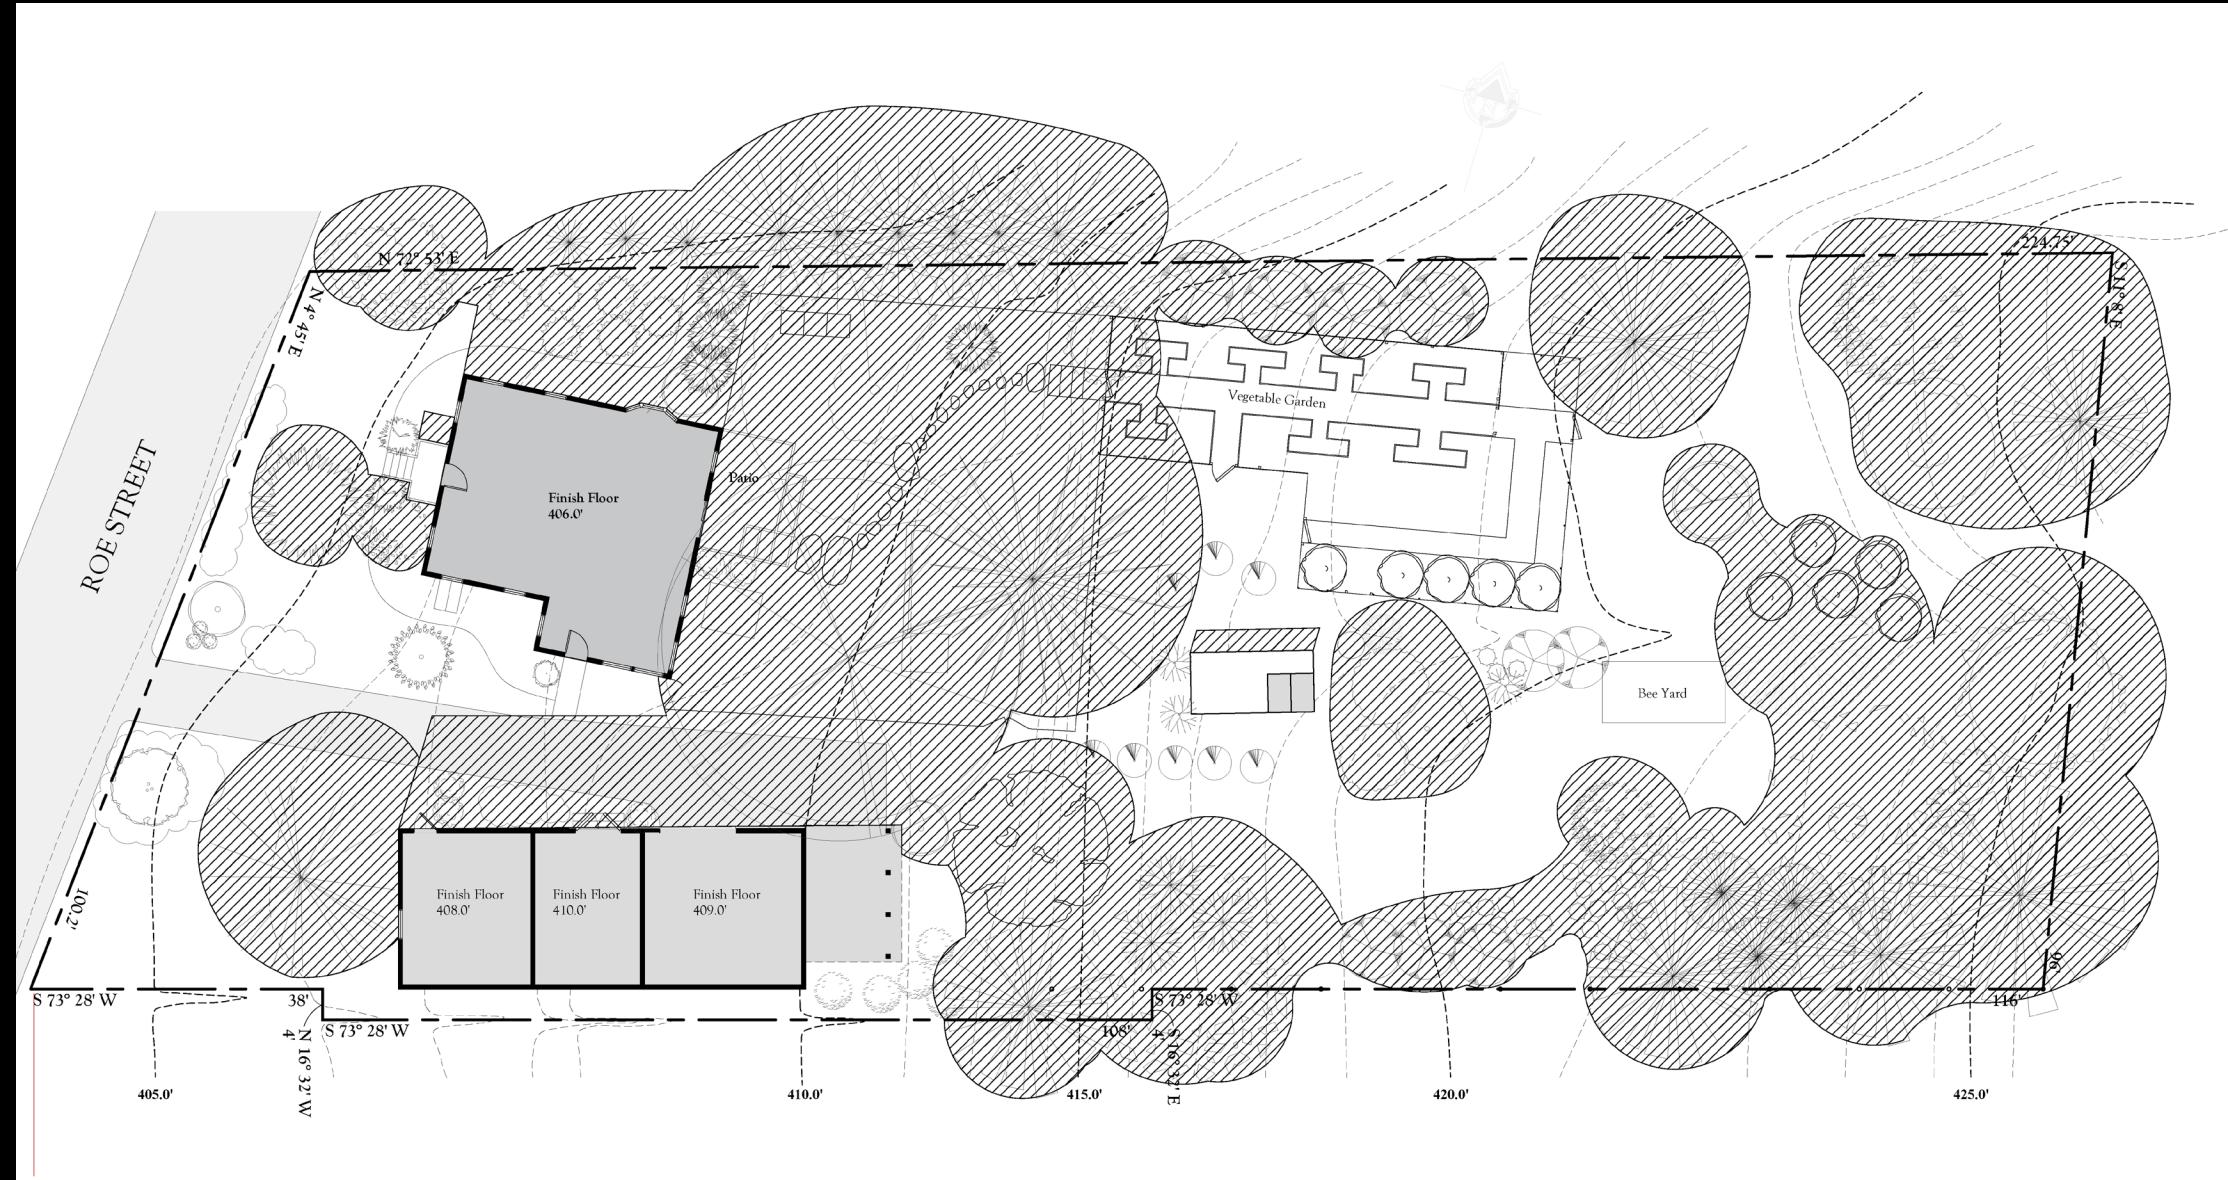


Site Analysis

- Sun
- Shade

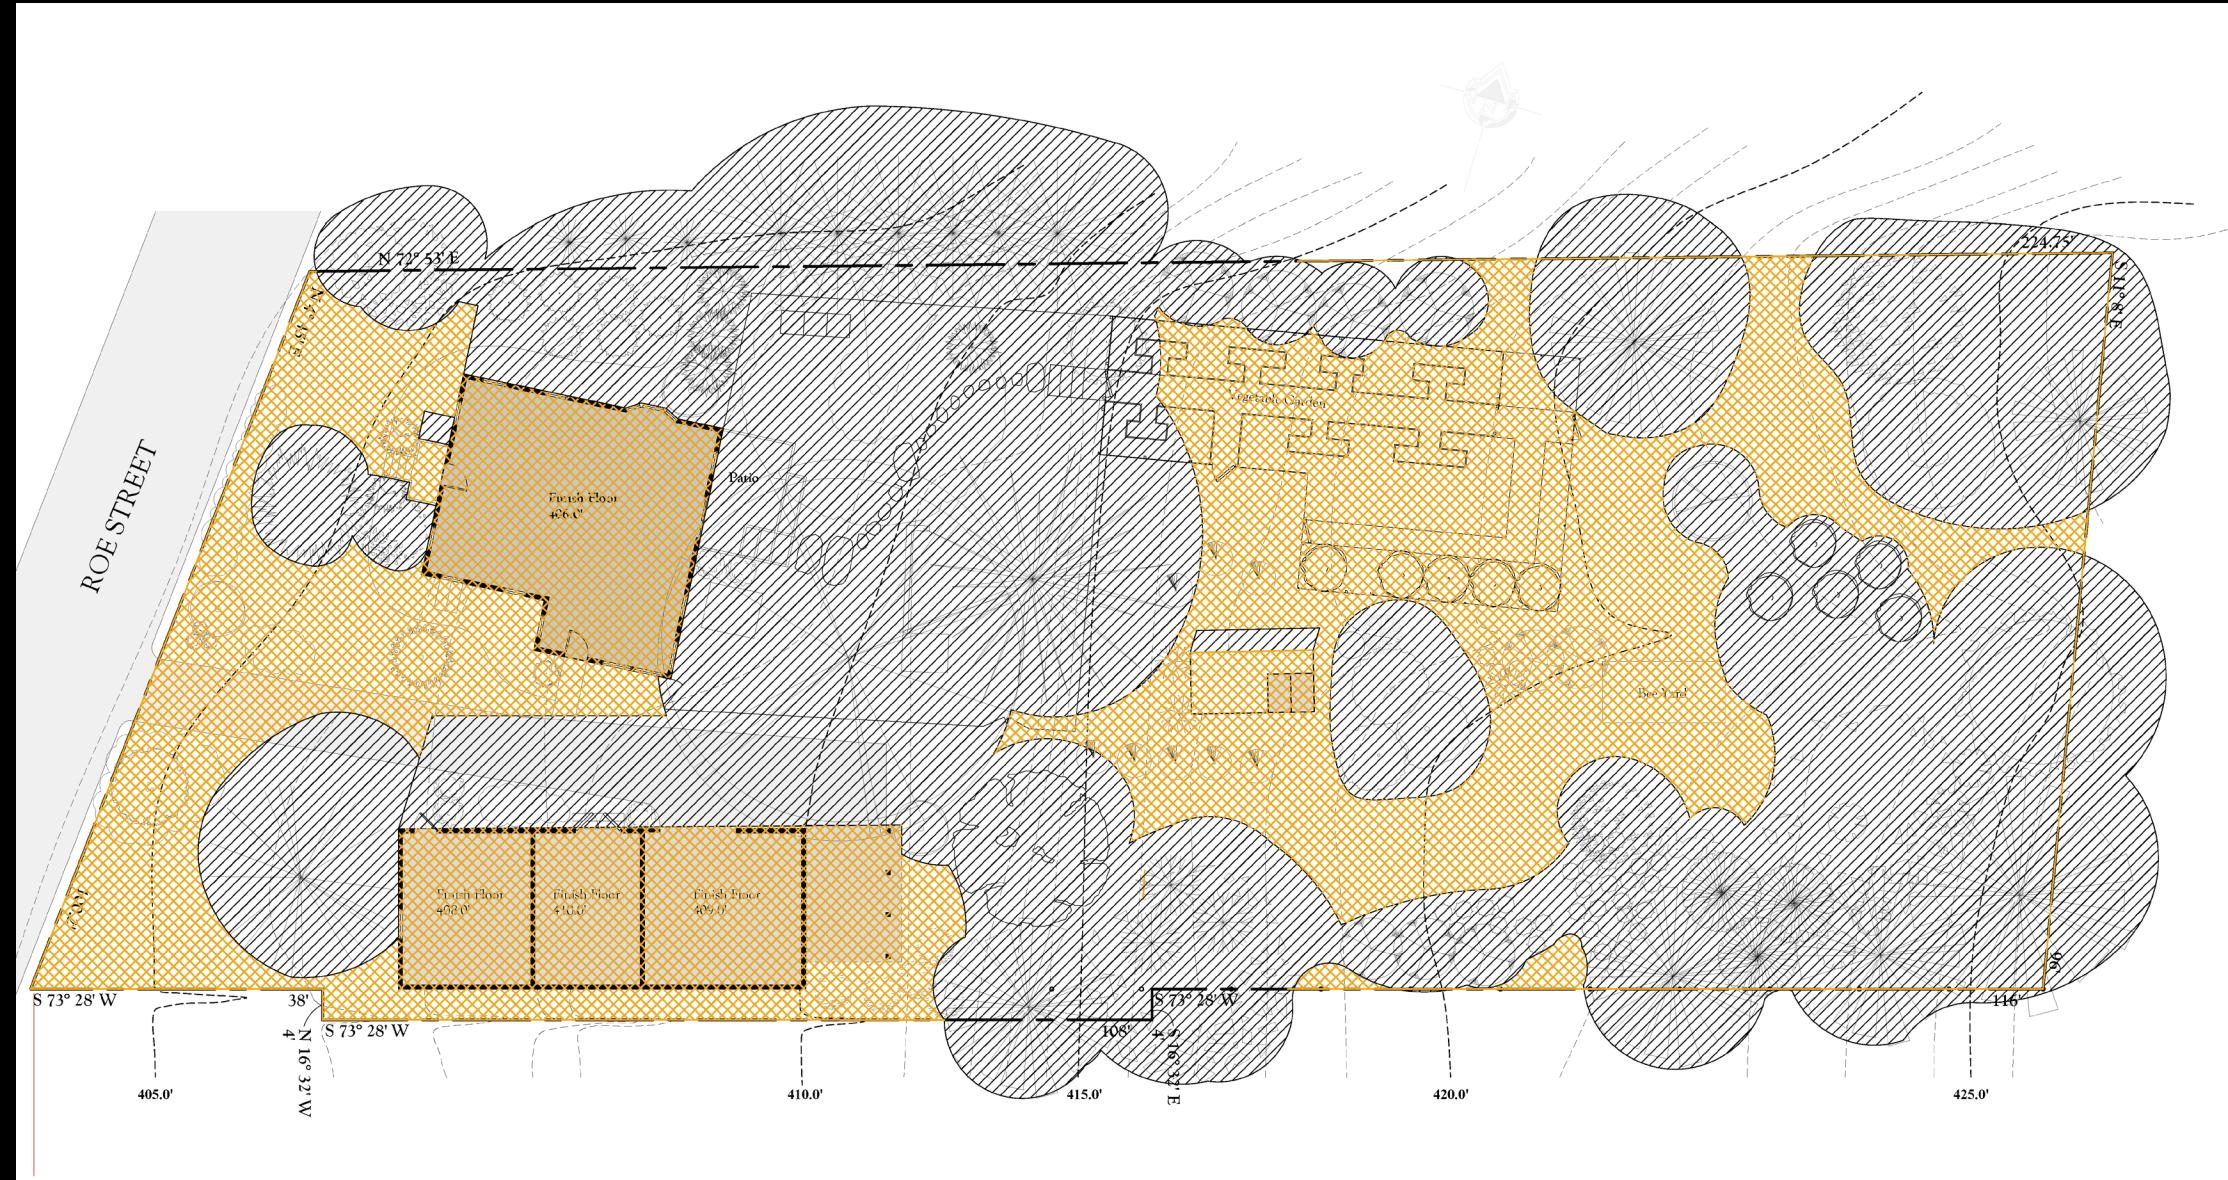


Site Analysis

- Water

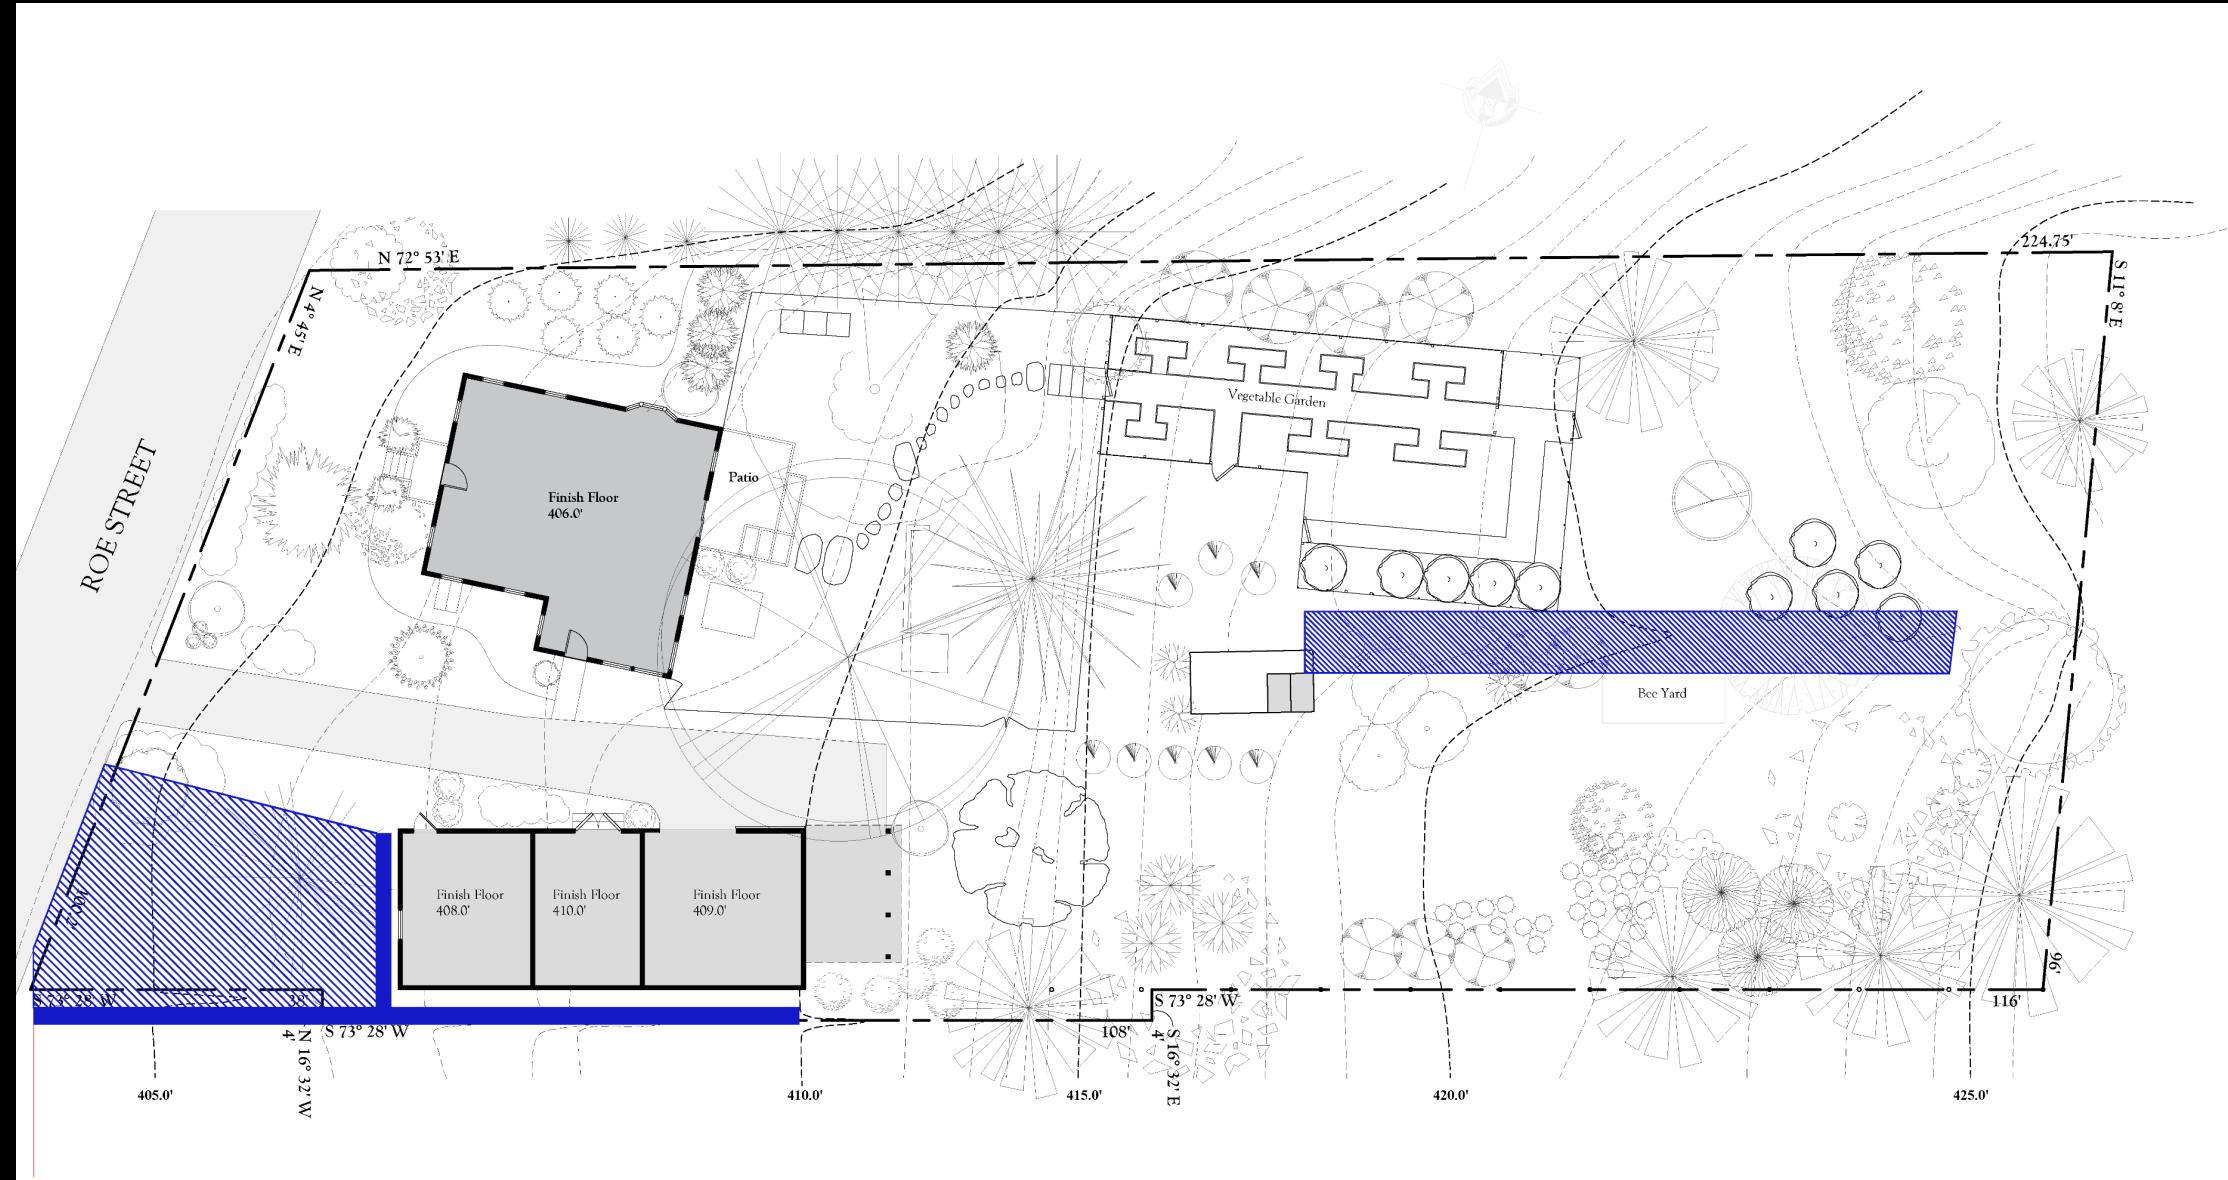


Site Analysis

- Views from Neighbors

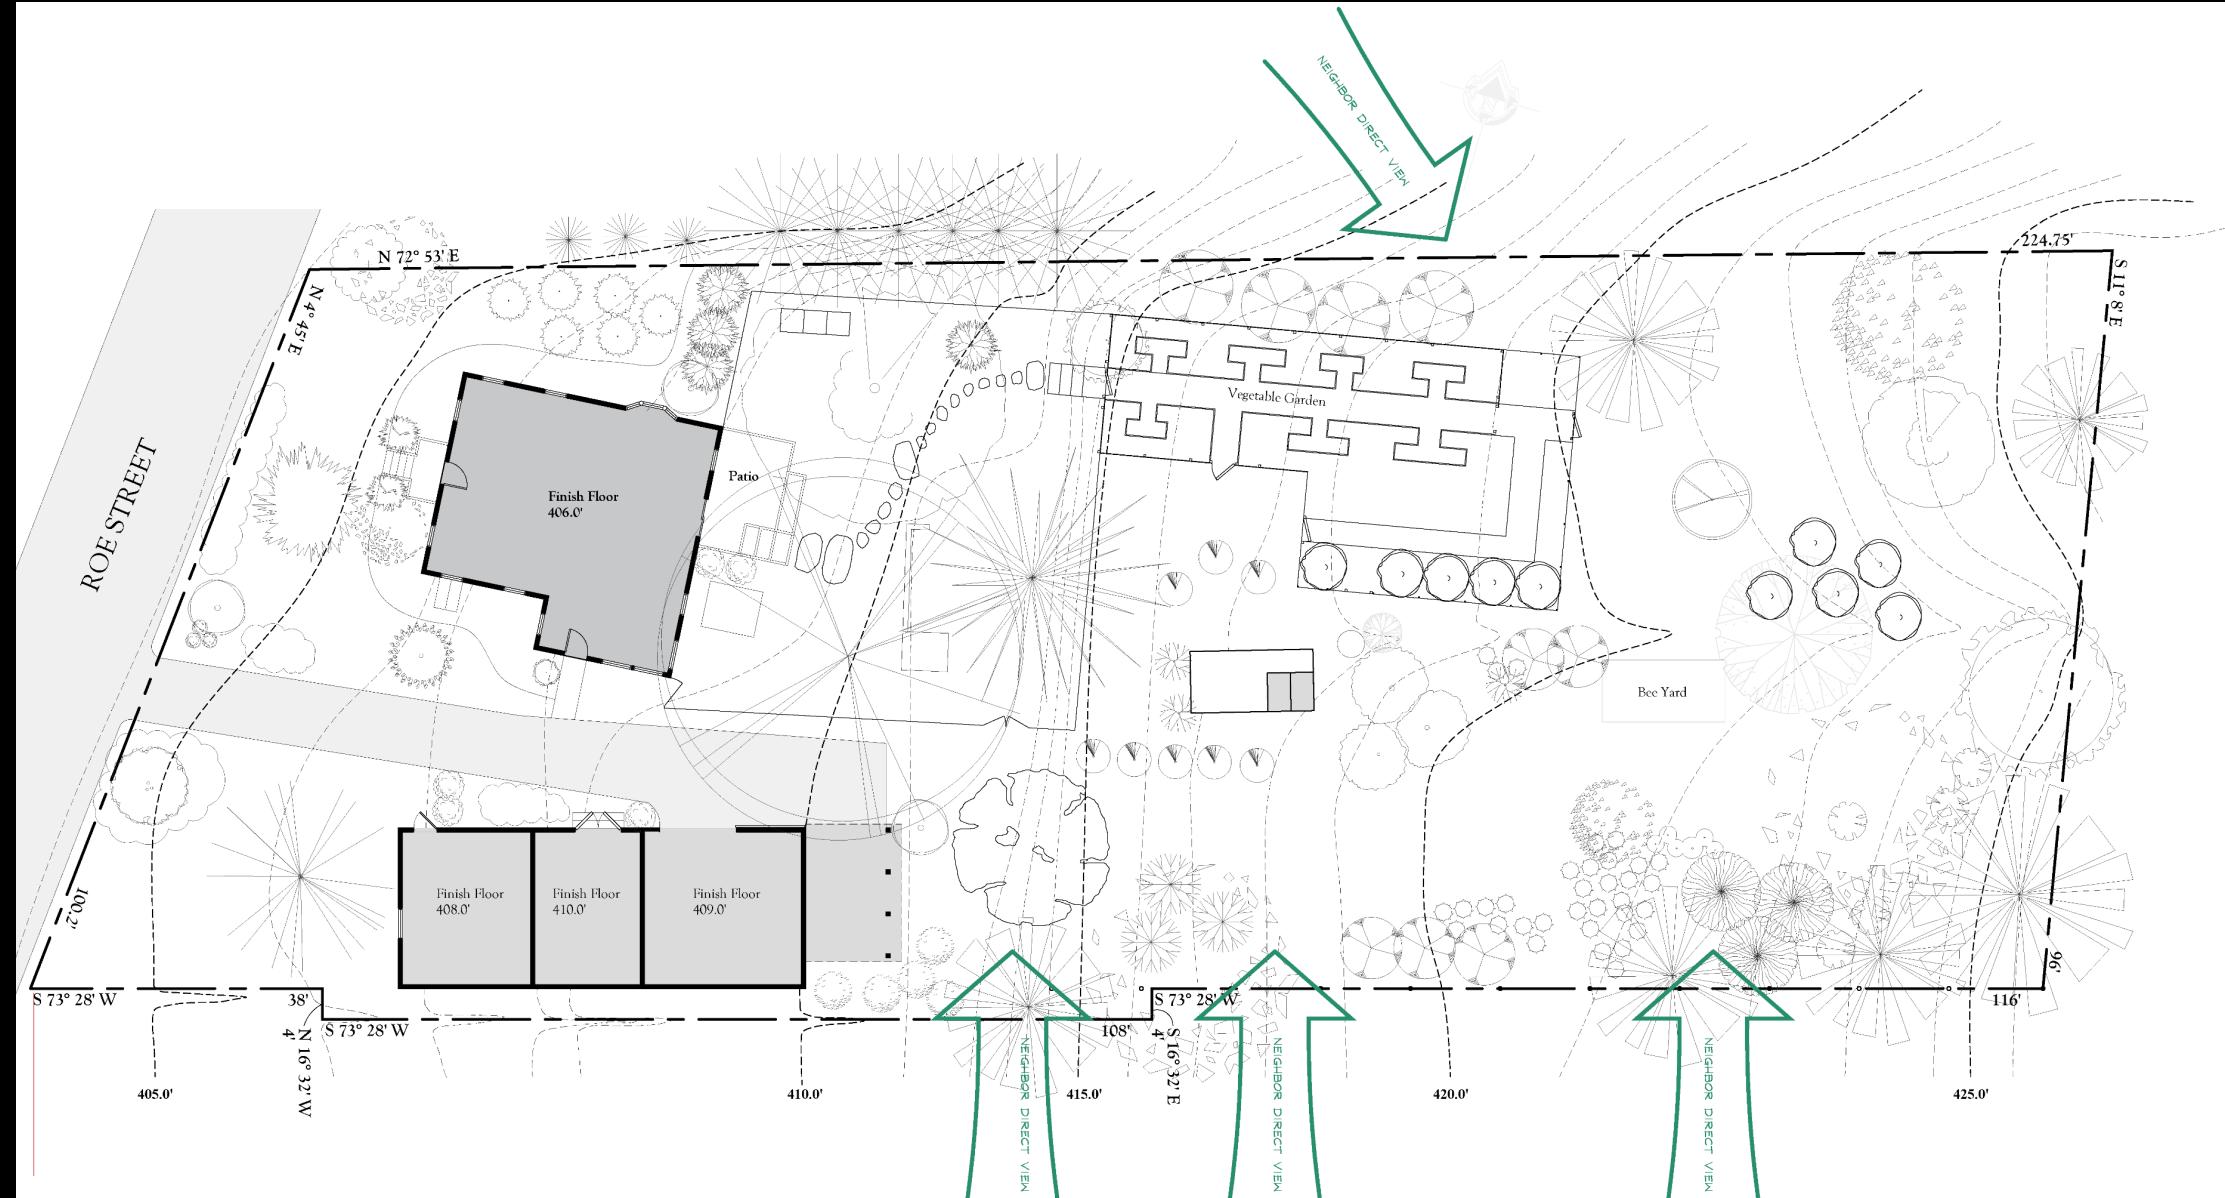


Site Analysis

Wind

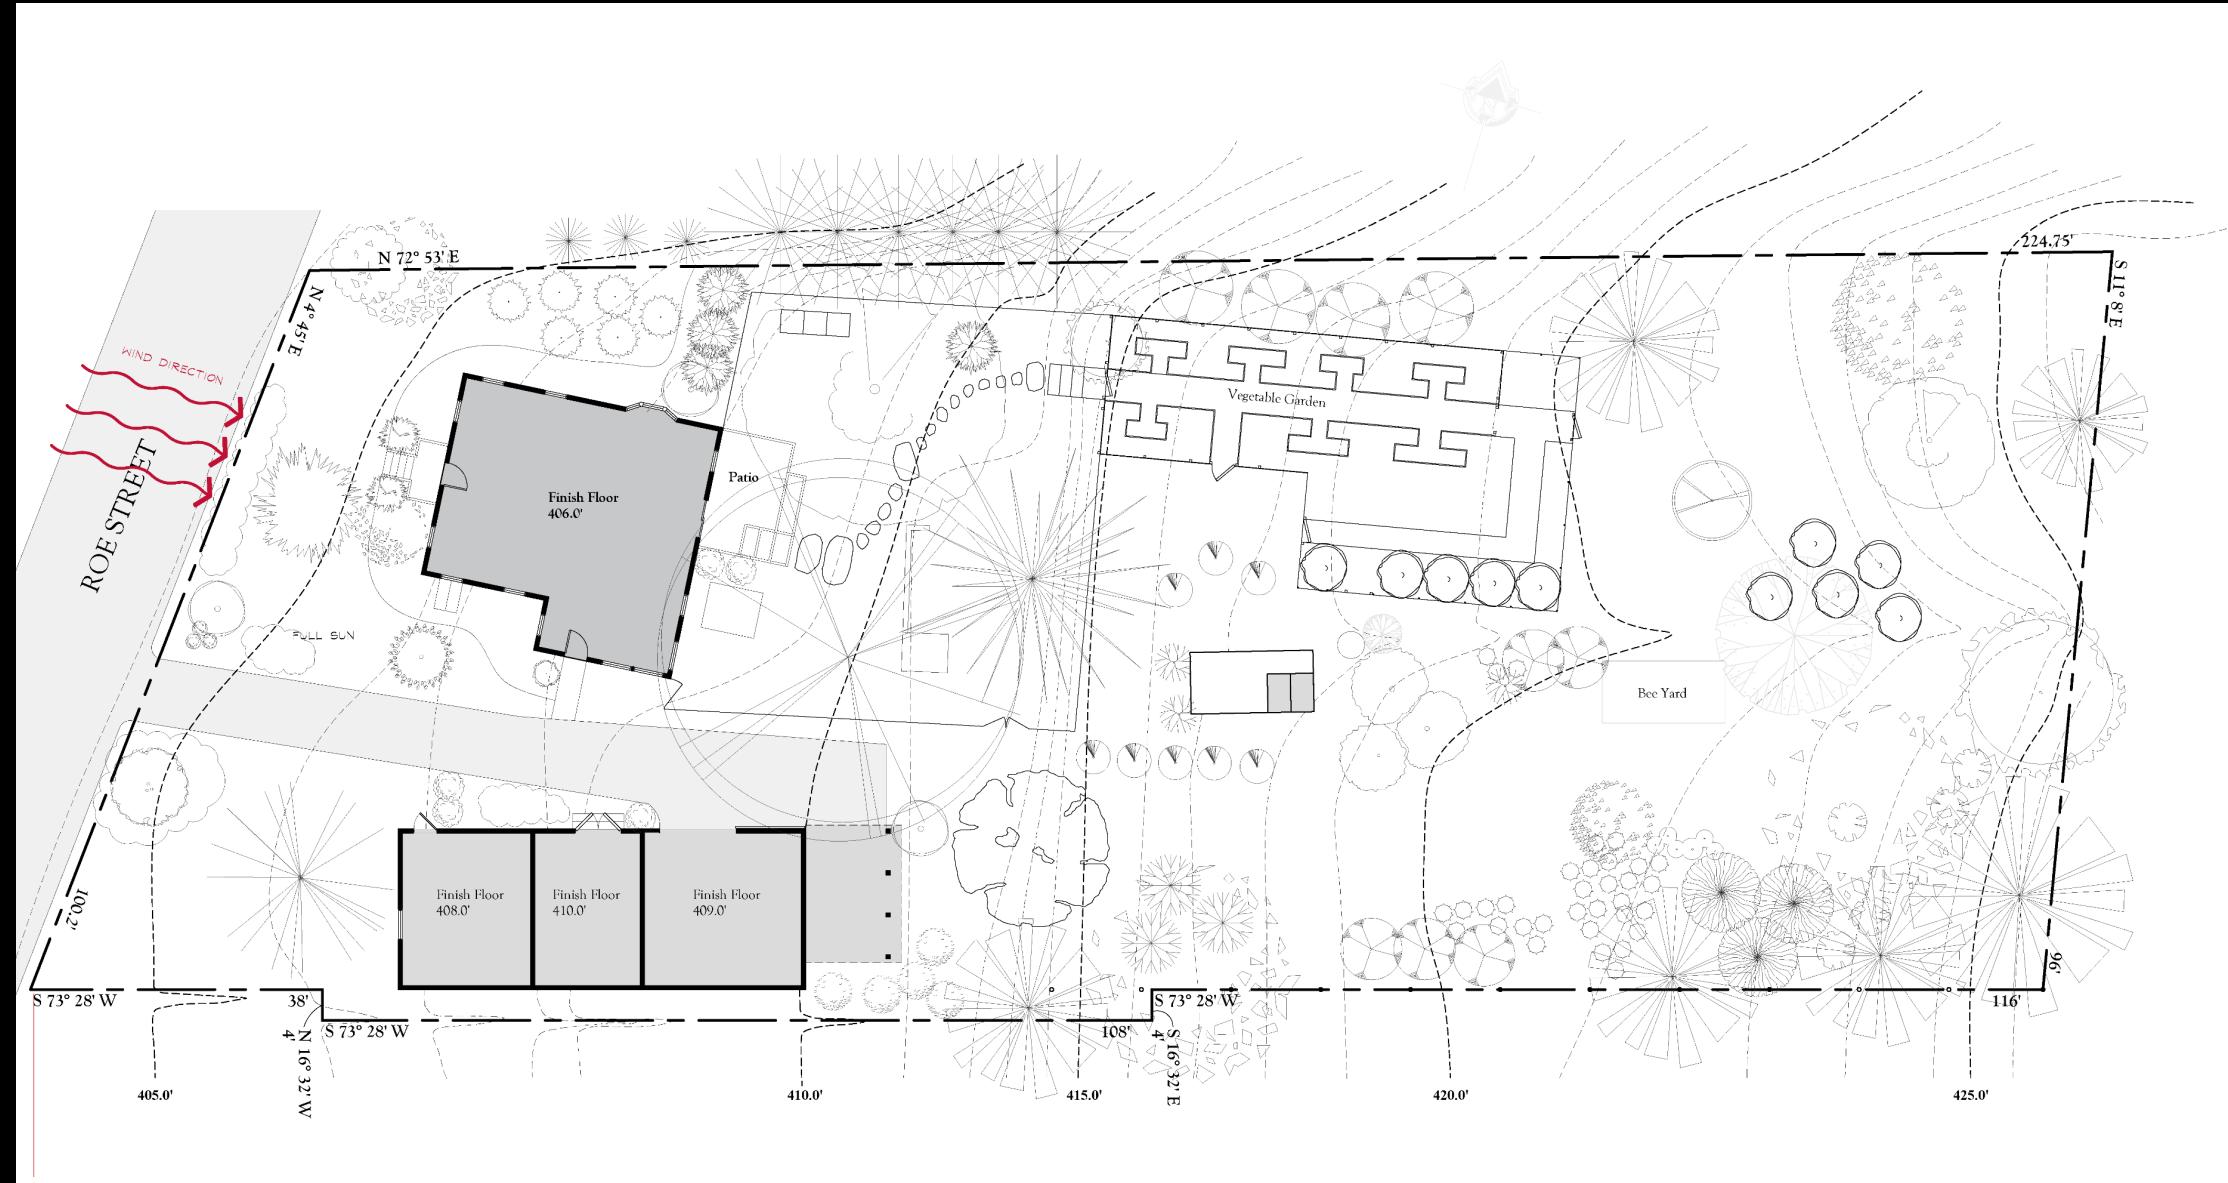

Site Analysis

- Sun
- Shade
- Water
- Views from Neighbors
- Wind

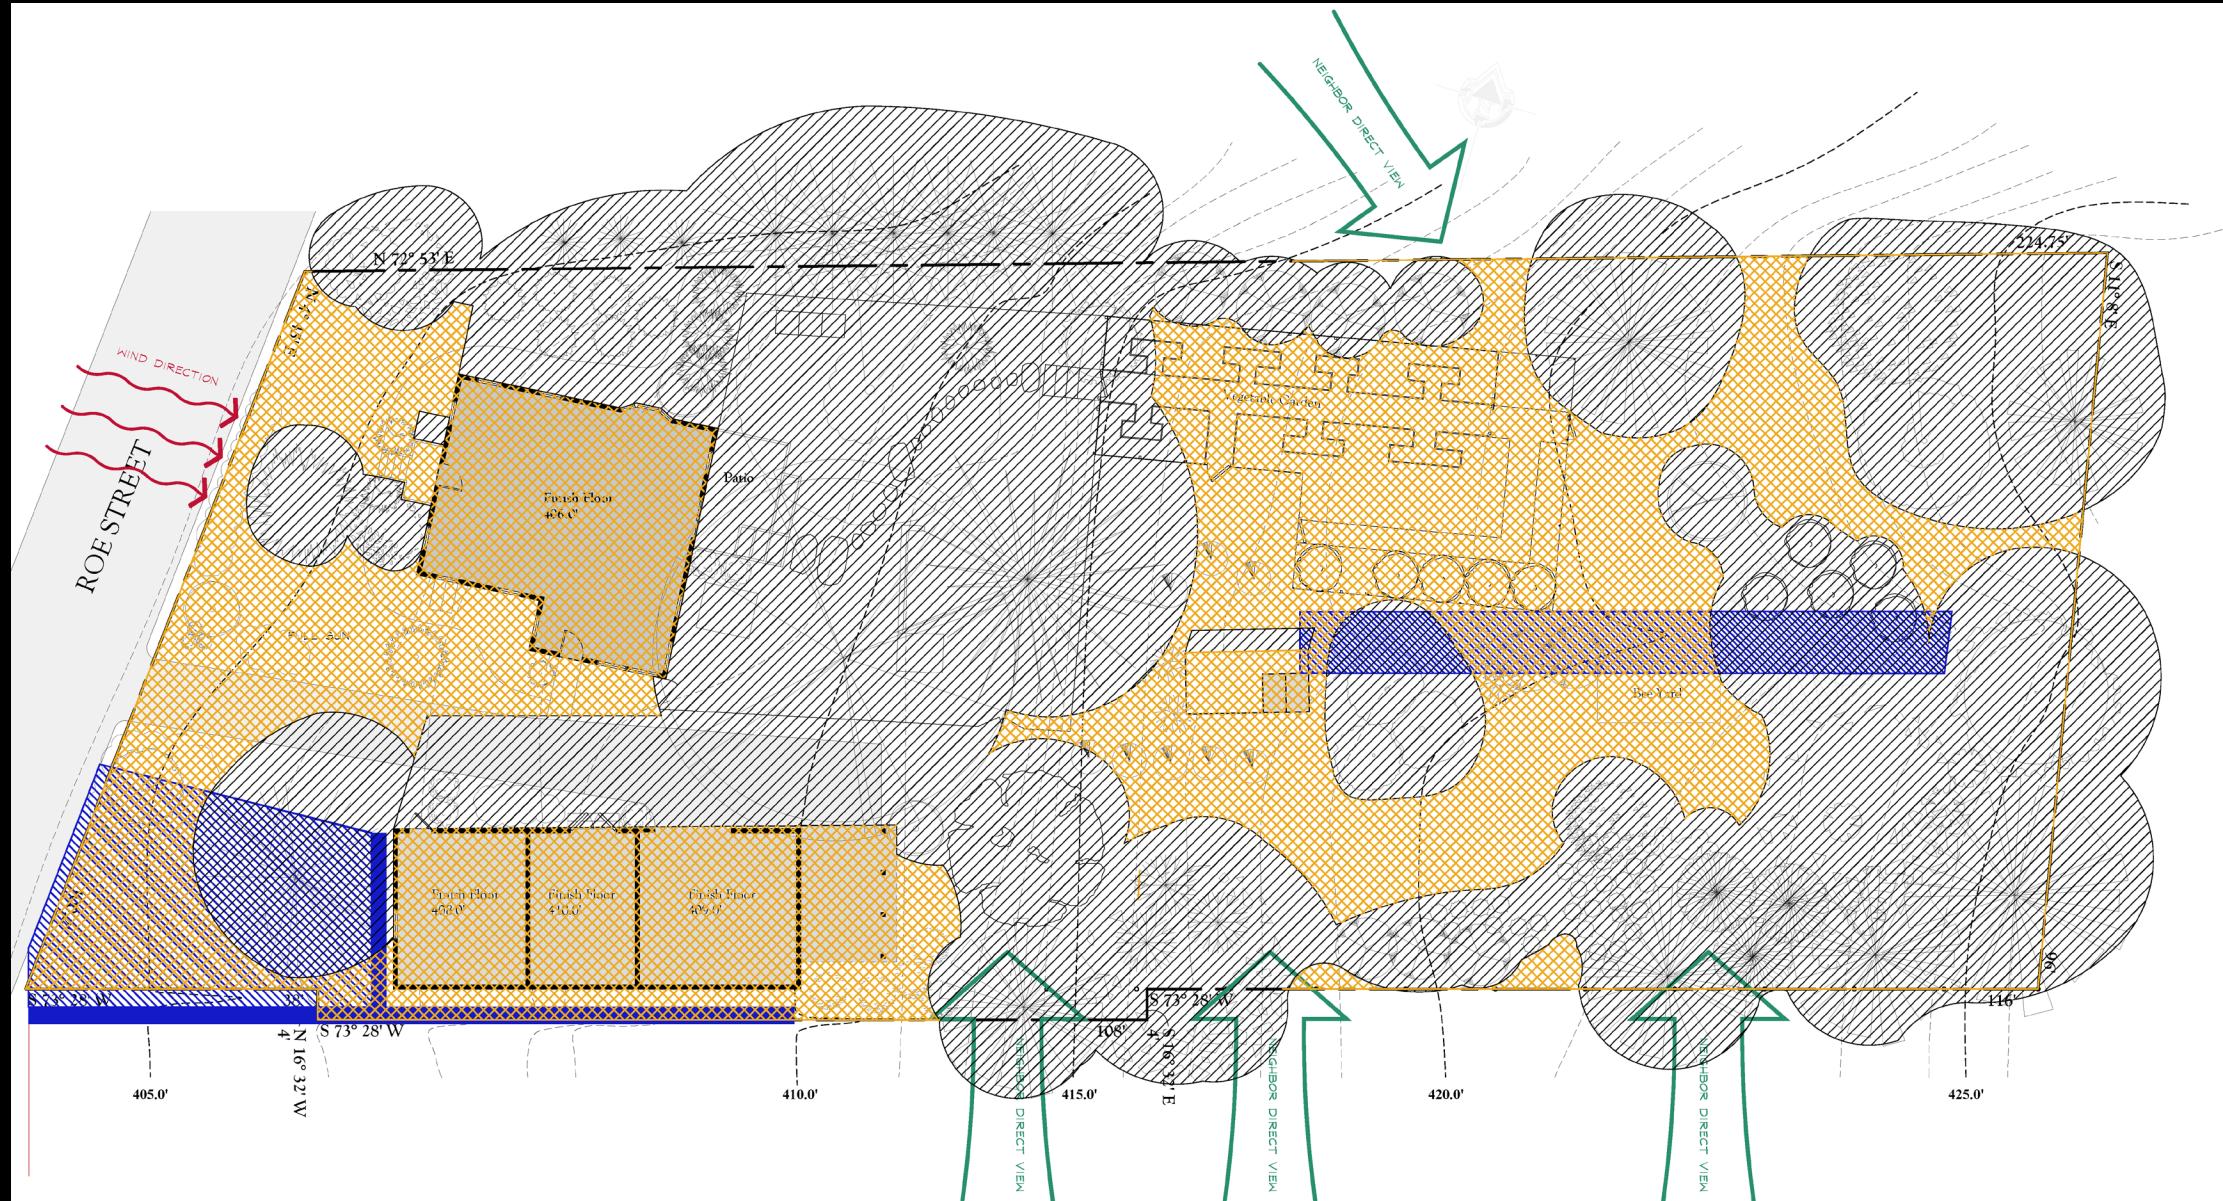

Preliminary Design: Program Requirements

Permaculture / Natural / Wildlife Garden
Edible Landscape

Xeriscape
Mushroom Yard

Bee Yard

Continuous Blooms throughout 3 seasons

Increase biodiversity

Pets: Dogs, cats

Limited outdoor entertaining


Avid Gardeners

Block Views from Neighbors

Bubble Diagram

Program Requirements
Explore Relationships between Program parts
Try different arrangements

Design Development: Bubble Diagram

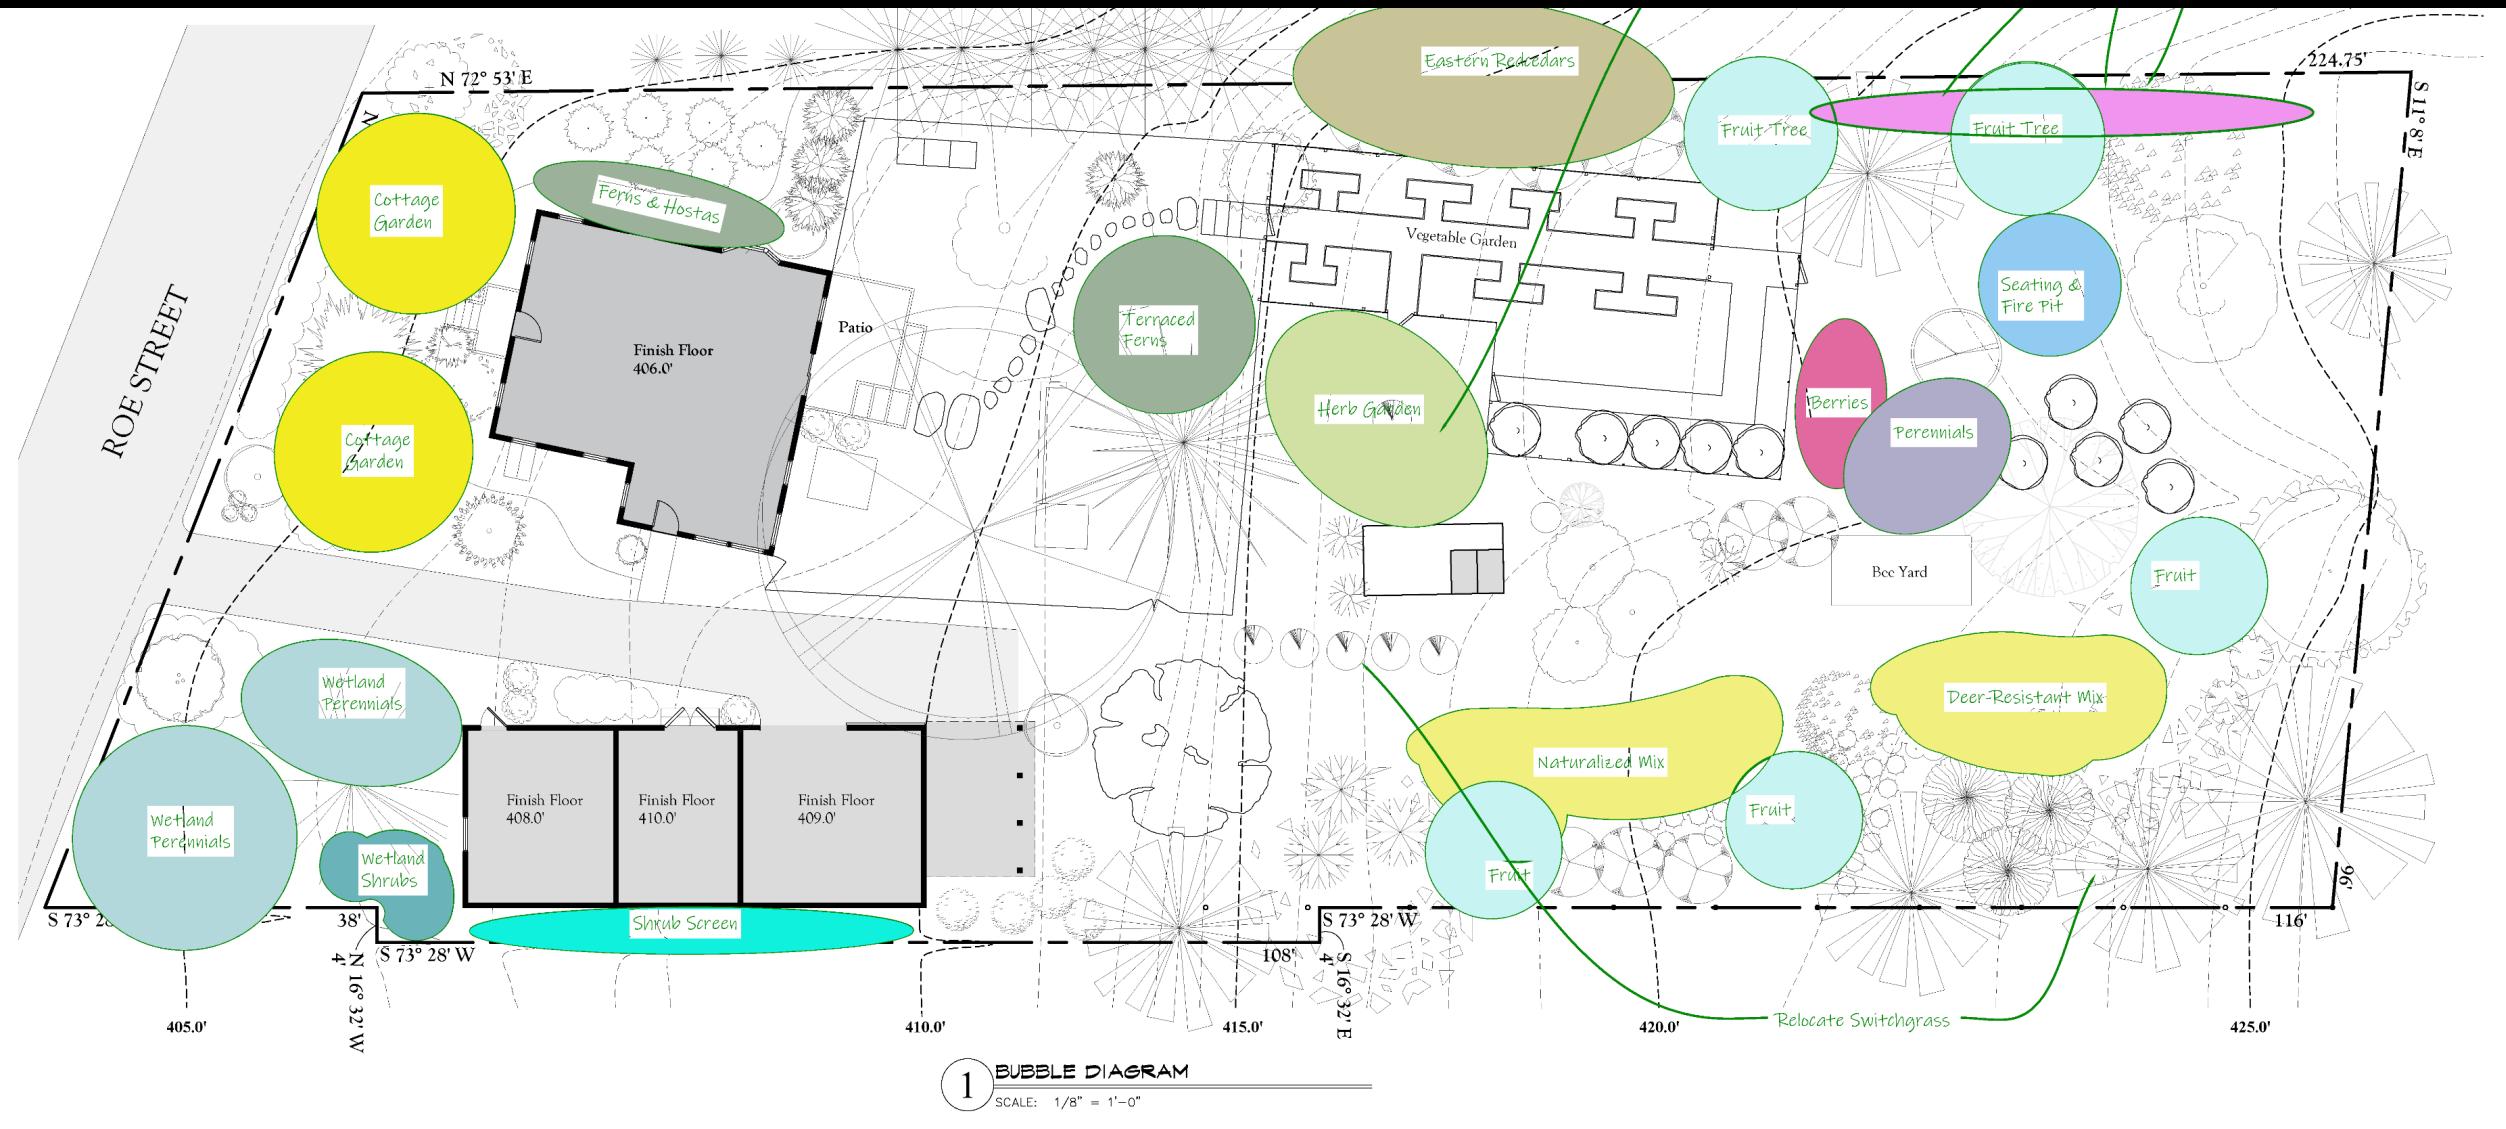

Planting Plan


Choose plants that satisfy both site and program requirements

Group plants

Highlight Specimen plants

Follow Design principles

Planting Plan: Trees and Grasses

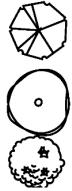

Prunus maritima, Beach Plum



Alnus incana subsp. rugosa, Speckled Alder



Physocarpus opulifolius, Prairie Ninebark




Asimina triloba, Common Paw Paw



Juniperus virginiana, Eastern Redcedar



Ptelea trifoliata, Wafer Ash

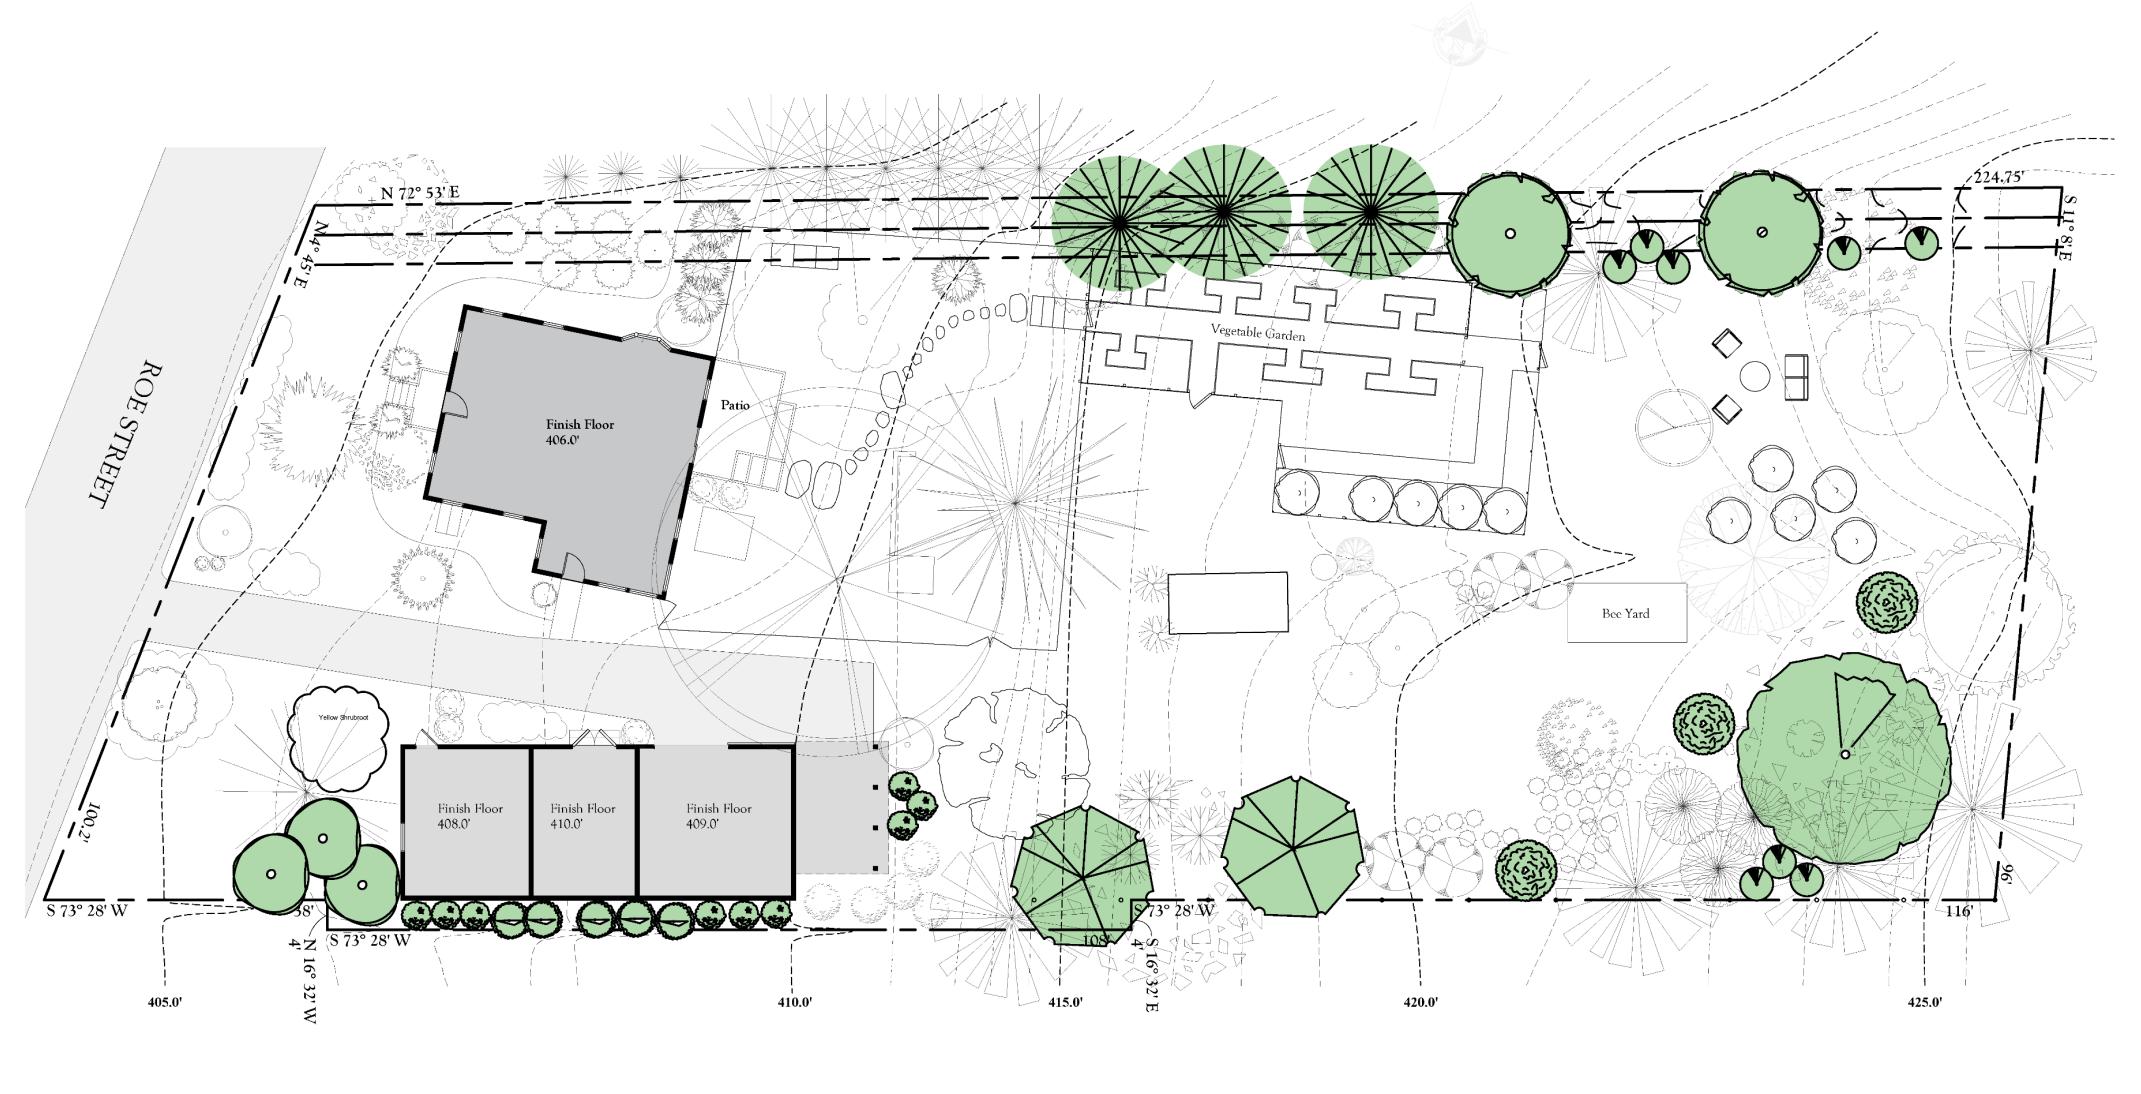

Choosing Plants

Cornell Woody Plants Database

<http://woodyplants.cals.cornell.edu/home>

University of Connecticut Plant Database

<http://hort.uconn.edu/>

Grow Native Plant Picker

<https://grownative.org/native-plant-info/plant-picker/>

Audubon Native Plants Database

<https://www.audubon.org/native-plants>

USDA Plant Database

<https://plants.sc.egov.usda.gov/java/>

Lady Bird Johnson Wildflower Center

<https://www.wildflower.org/plants/>

National Wildlife Federation Native Plant Finder

<https://www.nwf.org/NativePlantFinder/About>

Homework

Choose one scenario

Analyze the site

Explore program requirements with bubble diagrams

Try different design principles to relate the bubbles to one another

Create bubble diagram, identifying each program requirement

Extra Credit:

Develop a Planting Plan

Student Name

Scenario #

Overall Grade

Site Analysis	(20 points possible)
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Components of analysis to be graded are ability to read a site plan (8 points), ability to understand grade/topography (7 points), understand the way the sun moves across the site (5 points)

Total

Program Requirements	(20 points possible)
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Each program requirement for the Scenario chosen will count as one item to be graded i.e., if there are 5 program requirements, each item will be worth 4 points

Total

Design Principles Used	(10 points possible)
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Did you use any design principles in the bubble diagram? Using any of the design principles in the moodle materials or in the handouts will result in credit. The more principles you use, the more credit you will receive

Total


Plant Selections	(10 Bonus points possible)
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Bonus points for selecting plants - the only way to lose bonus points is to choose invasive plants or choose plants inappropriate to the location

Total

Comments

An opportunity for me to point out the things I see in your design and suggest areas you may want to develop a little more

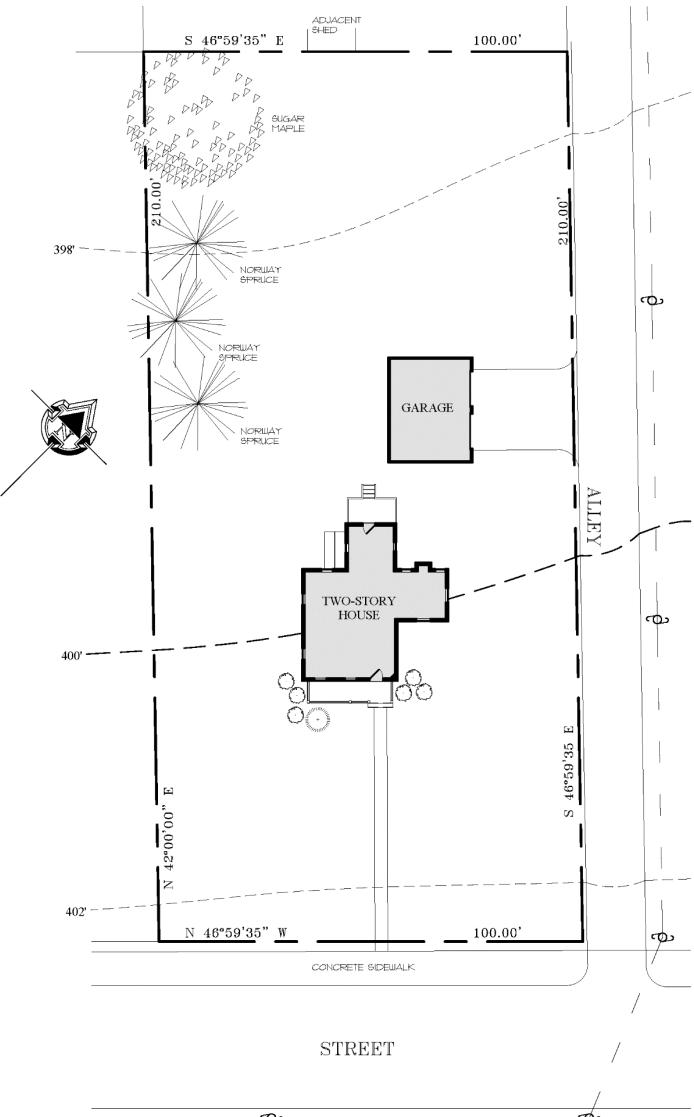


1 EXISTING SITE PLAN

SCALE: 1" = 20'

SCENARIO 1

BACKGROUND:	WANT:
YOUNG FAMILY, 2 ADULTS, 3 SMALL CHILDREN SUBURBAN SETTING COLONIAL STYLE HOUSE MODERATE INCOME SUNNY VIEWS OF UTILITY POLES	PLAY AREA FOR CHILDREN CHILDREN'S GARDEN PATIO AREA WITH GRILL VEGETABLE GARDEN POOL RAIN GARDEN TO COLLECT STORM WATER RUNOFF

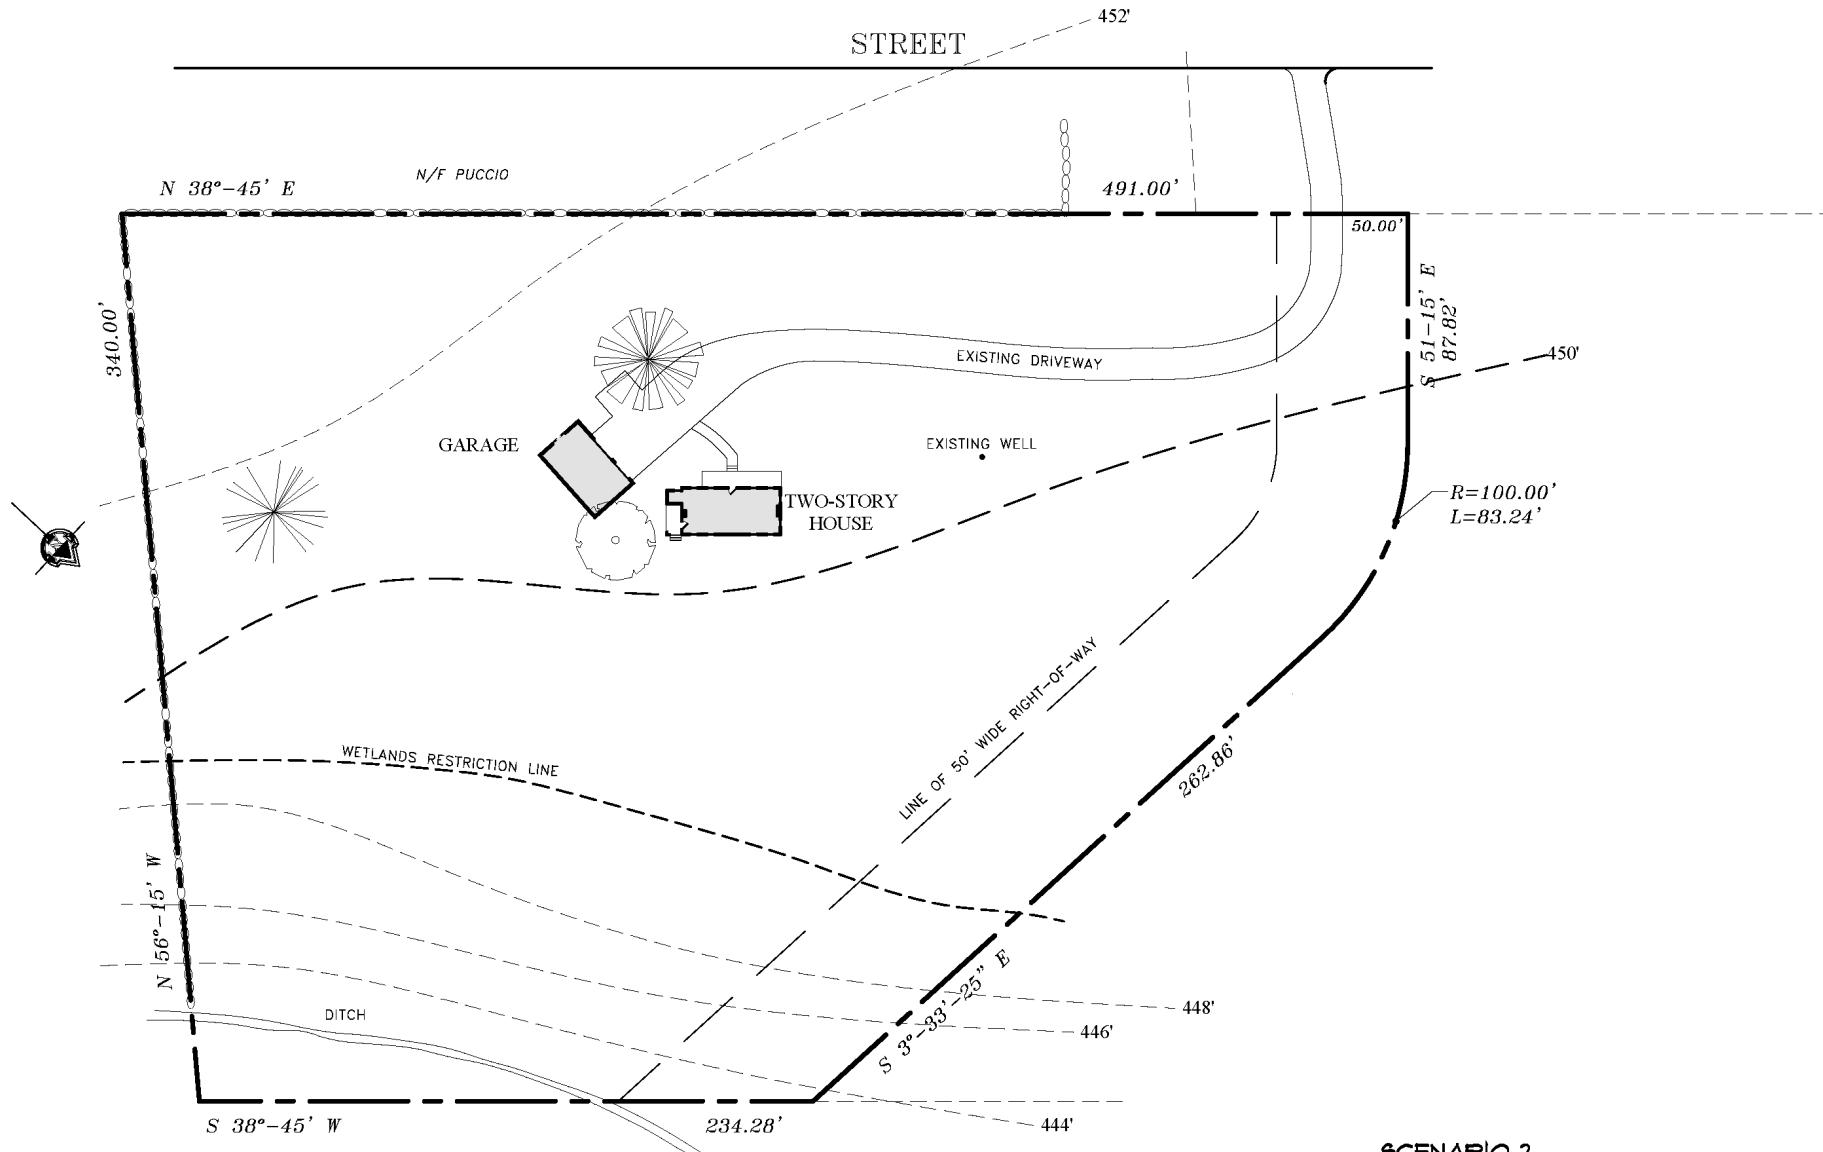


1 EXISTING SITE PLAN

SCALE: 1" = 50'

SCENARIO 2

BACKGROUND:	WANT:
<p>COUPLE IN THEIR MID FORTIES WITH 2 TEENAGE CHILDREN OLDER STYLE FARM HOUSE COUNTRY SETTING SUNNY LOCATION WINDS FROM THE WEST MODERATE INCOME AVID GARDENERS</p>	<p>VEGETABLE GARDEN COMPOSTING AREA HERB GARDEN OUTDOOR LOUNGING AND SITTING AREA BLOCK THE WINTER WINDS GRASSY AREA FOR KIDS TO PRACTICE SOCCER</p>

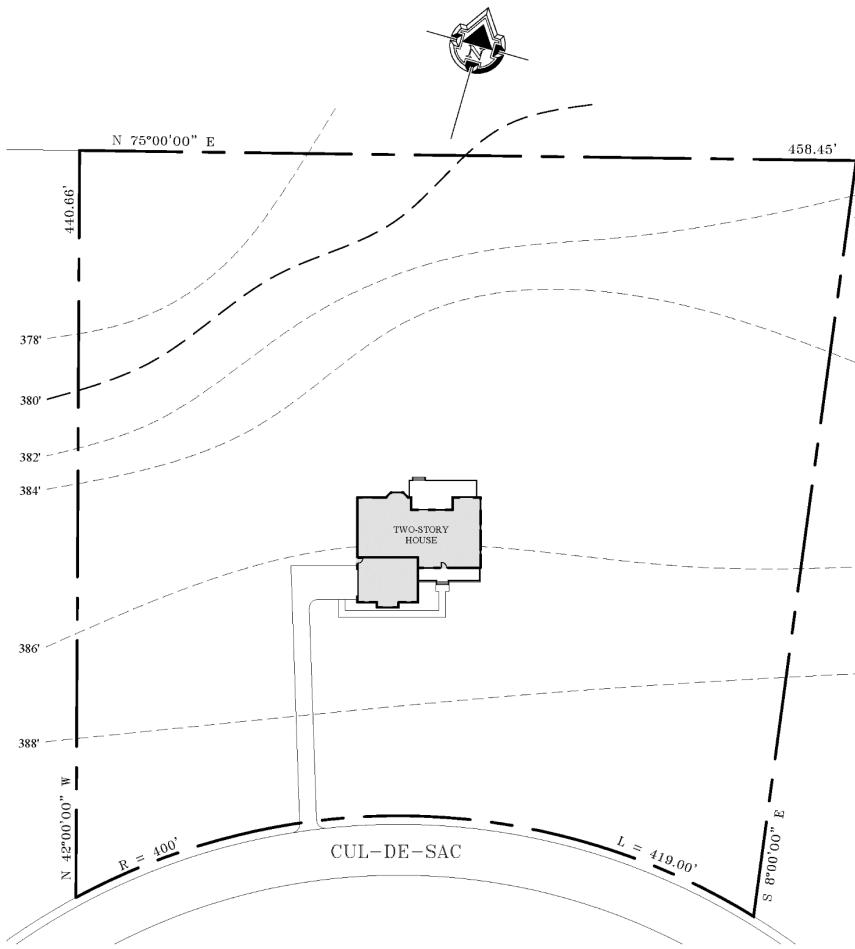


1 EXISTING SITE PLAN

SCALE: 1" = 50'

SCENARIO 3

BACKGROUND:	WANT:
COUPLE IN MID-FORTIES WITH 2 YOUNG CHILDREN SUBURBAN SETTING McMANSION TYPE HOUSE HIGH INCOME, WILL HIRE A GARDENER SUNNY UGLY VIEW OF NEIGHBOR'S HOUSE AND YARD	PERENNIAL BEDS MIXED SHRUB BORDERS OUTDOOR KITCHEN AND DINING AREA PRIVATE PLAY AREA FOR CHILDREN PRIVACY AREA FOR PETS

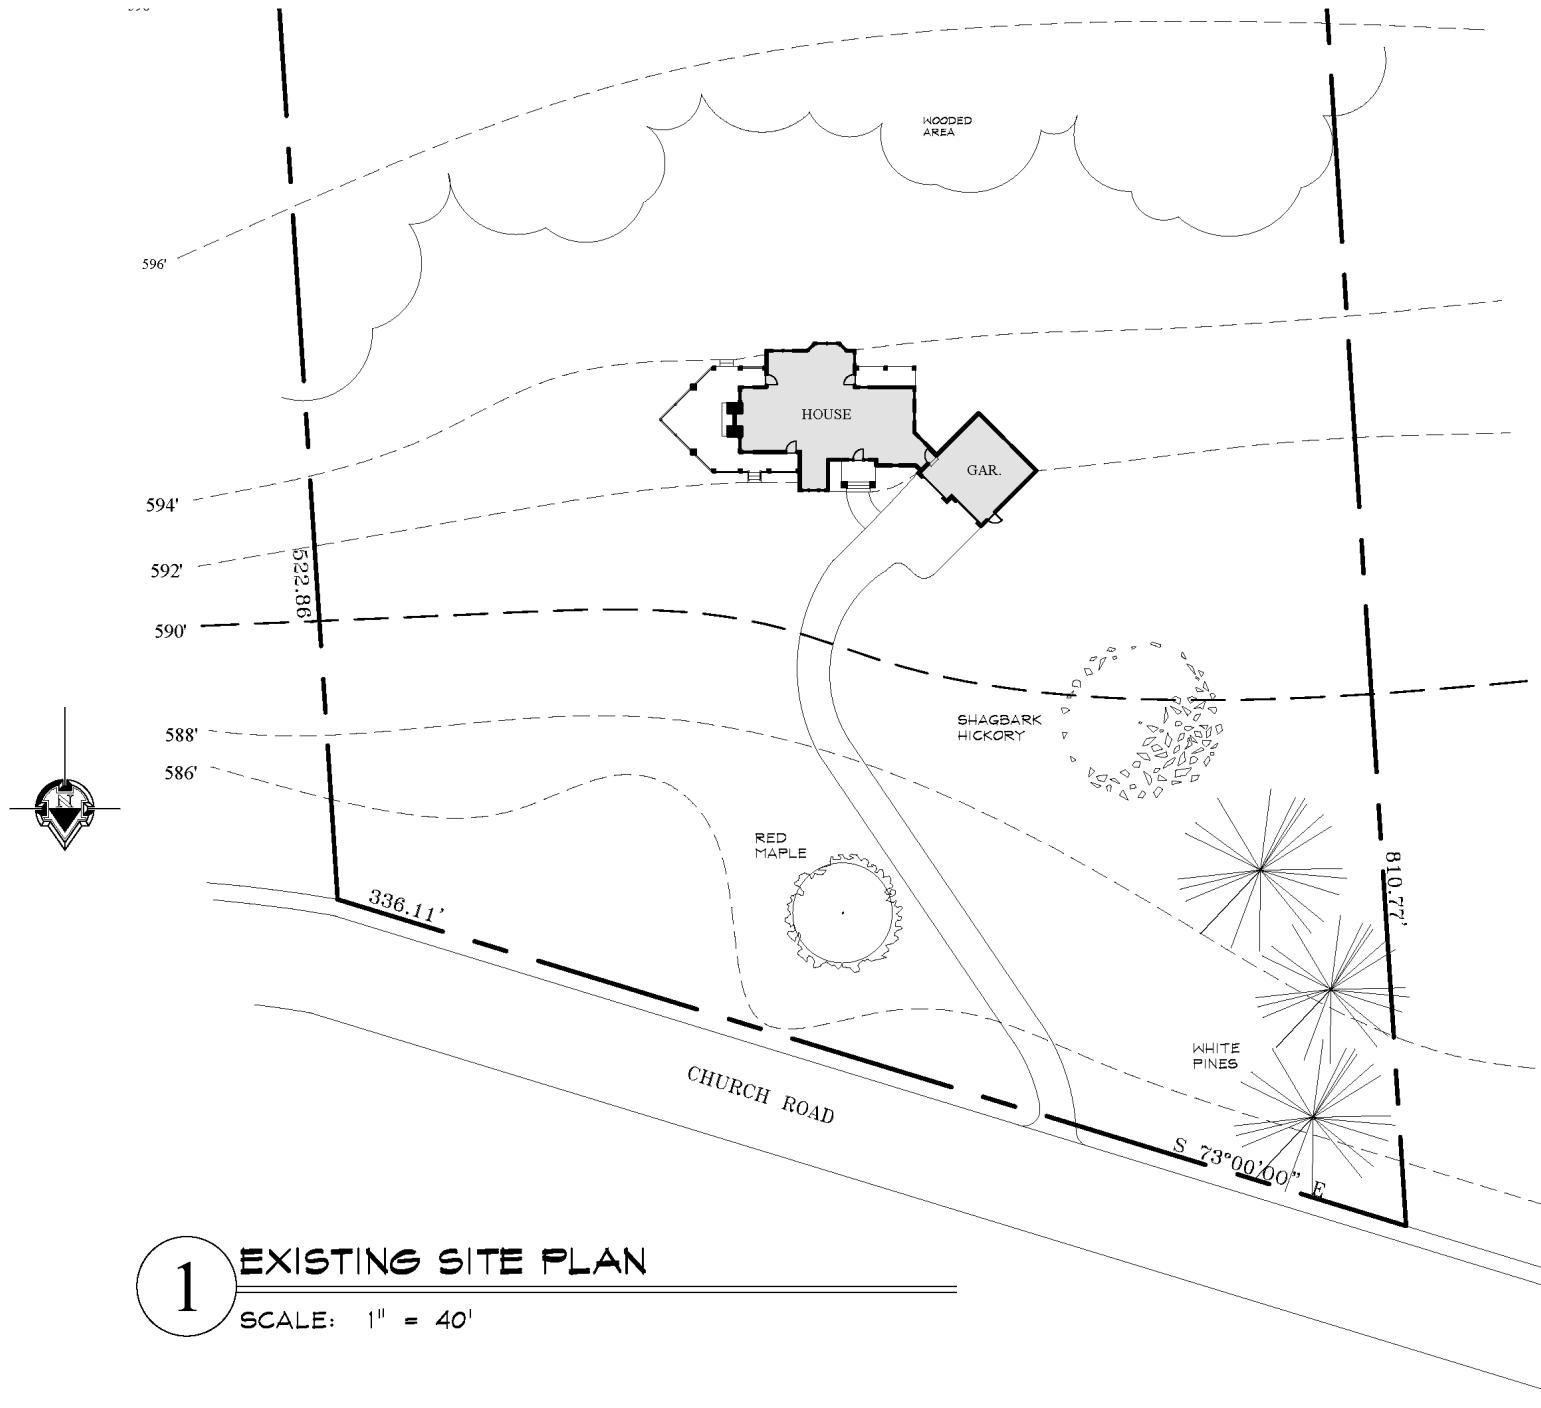


SCENARIO 4

BACKGROUND:

COUPLE IN MID-FIFTIES, NO CHILDREN LIVING AT HOME
 CRAFTSMAN STYLE HOUSE
 COUNTRY SETTING
 MEDIUM TO HIGH INCOME
 WOODED AREA IN BACK YARD, SHADED
 LOW MOIST ARE IN FRONT YARD, SUNNY
 LIKE GARDENING AND WILL SPEND WEEKENDS IN YARD

WANT:

NATURAL LOOK AND FEEL
 WATER GARDEN
 PATIO AREA FOR OUTDOOR LIVING
 VEGETABLE GARDEN
 AREA TO STORE WOOD FOR FIREPLACE
 MIXED SHRUB BORDER

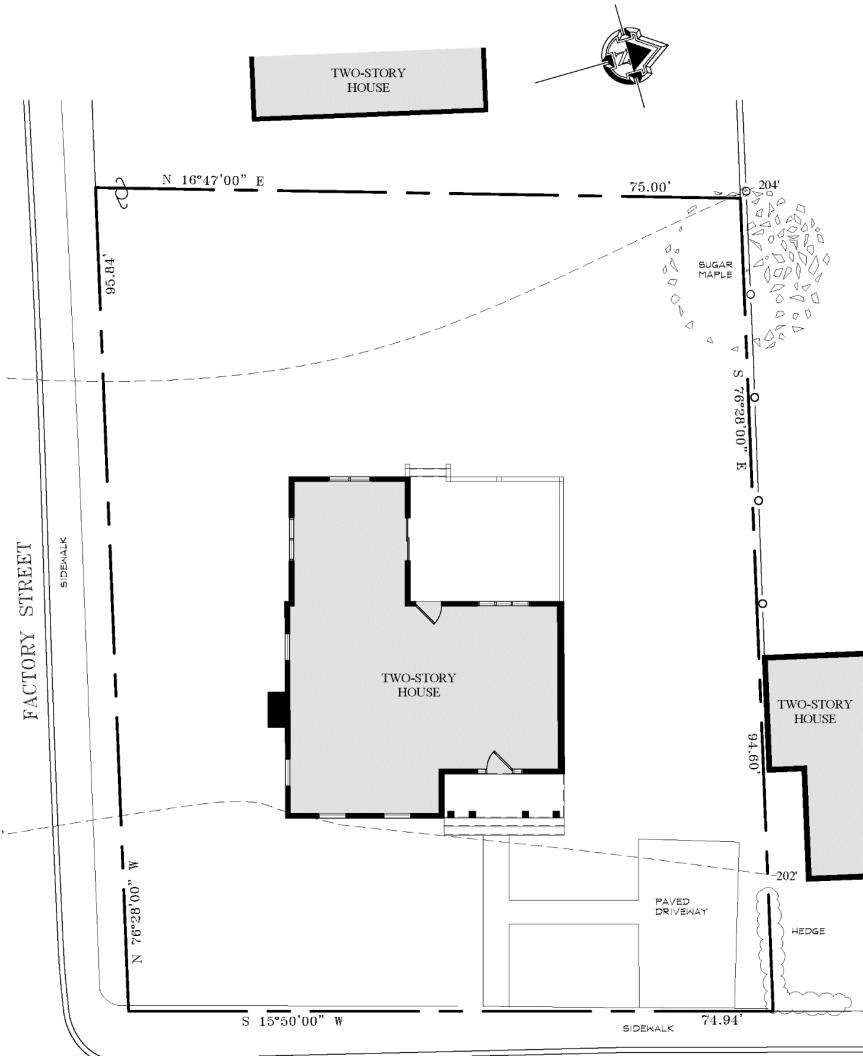

1 EXISTING SITE PLAN

SCALE: 1" = 10'

SCENARIO 5

BACKGROUND:	WANT:
COUPLE IN MID-SIXTIES, NO CHILDREN CITY HOUSE RELATIVELY SMALL YARD SUNNY HIGH INCOME REAR NEIGHBOR CAN LOOK DIRECTLY INTO YARD	FORMAL GARDENS ENTERTAINING AREA LOW MAINTENANCE SMALL WATER FEATURE LIKE A FOUNTAIN PRIVACY